

&	And	INSUL	Insulated or Insulation	T&G	Tongue And Groove
@	At	INT	Interior	TLT	Toilet
AFF	Above Finished Floor	LO	Low	TME	To Match Existing
BSMT	Basement	MAX	Maximum	TO	Top Of
BYND	Beyond	MO	Masonry Opening	TOT	Top Of Concrete
BOT	Bottom	MECH	Mechanical	TPD	Toilet Paper Dispenser
CLG	Ceiling	MIN	Minimum	T/D	Telephone/Data
CLR	Clear	MTL	Metal	Typ	Typical
CMU	Concrete Masonry Unit	NI	New	UNO	Unless Noted Otherwise
COL	Column	NI	Not In Contract	U/S	Underside
CONC	Concrete	NO	Number	VIF	Verify In Field
CONT	Continuous	NOM	Nominal	W/	With
CPT	Carpet	NTS	Not To Scale	WD	Wood
CT	Ceramic Tile	OC	On Center		
DBL	Double	OH	Overhang		
DEMO	Demolish or Demolition	OPP	Opposite		
DIA	Diameter	OZ	Ounce		
DIM	Dimension	PLUMB	Plumbing		
DIMS	Dimensions	PLYD	Plywood		
DN	Down	PT	Pressure Treated		
DR	Door	PNT	Paint or Painted		
DWG	Drawing	PVC	Polyvinyl Chloride		
EA	Each	RBR	Rubber		
EL	Elevation	RPC	Reflected Ceiling Plan		
ELEC	Electrical	RD	Roof Drain		
ELEV	Elevation	REQD	Required		
EQ	Equal	RM	Room		
[E]	Existing	SIM	Similar		
EXT	Exterior	SPEC	Specification		
FIXT	Fixture	SPK	Sprinkler or Speaker		
FLR	Floor	SSTL	Stainless Steel		
GWB	Gypsum Wall Board	STC	Sound Transmission		
HVAC	Heating, Ventilating, And		Coefficient		
Air Conditioning		STL	Steel		
		STRUCT	Structural		

1. Occupancy Use: R5 1 Family
2. Construction Type: 5B
3. Ground Snow Load: 20 PSF
4. Wind Speed: 100 MPH
5. Seismic Category: N/A
6. Weathering: Severe
7. Frost Line Depth: 36"
8. Termites: Moderate to Heavy
9. Design Load:
 - Roof:
 - Live Load: 30 PSF
 - Dead Load: 12 PSF
 - Attic Areas:
 - Live Load: 20 PSF
 - Dead Load: 12 PSF
 - All Other Areas:
 - Live Load: 40 PSF
 - Dead Load: 12 PSF

1. Remove and legally dispose of all partitions noted for removal and associated debris such as (E) electrical + (E) plumbing as required to accommodate new construction.
2. Patch + repair (E) walls or partitions to remain where adjacent partitions have been demolished, removed, or replaced. New finishes shall match adjacent finishes unless noted otherwise.
3. Remove, store, clean, and reinstall (E) air supply, distribution grills and registers only as required to accommodate new construction and as required to avoid damage during construction activities.
4. All new exteriors windows, doors, openings, and penetrations shall be carefully flashed and counter flashed in accordance with standard practices for construction in accordance with manufacturer's recommendations. Typical unless noted otherwise.
5. Contractor to size all plumbing

Zoning / Use / Construction Classification		
Street Address:	248 Christopher Street, Montclair, NJ 07042	
Block: 4501	Lot: 4	Qual: N/A
Zoning Classification: R-1 Single Family		
FEMA Zone: N/A		

Regulation		Requirement	Existing	Proposed	Conforms
Lot	Min. Lot Area (SF)	N/A	N/A	No Change	Yes
	Min. Lot Frontage (ft)	N/A	N/A	No Change	Yes
	Min Lot Width (ft)	N/A	N/A	No Change	N/A
	Min. Lot Depth (ft)	N/A	N/A	No Change	Yes
Yards	Min. Front Yard (ft)	35'	39.7'	No Change	No
	Min Rear Yard (ft)	30' or 30%	70'-7"	50'-7"	Yes
	Min. Side Yard (ft)	6' one side / 10' other side	7.7' one side / 16' other side	7.7' one side / 13' other side	Yes
Min. Gross Floor Area (SF)		N/A	N/A	N/A	N/A
Max Coverage Principal Building		25%	13.1%	19.9%	Yes
Max. Height (ft / stories)		~35' / 2.5 Stories	~29.3' / 2.5 Stories	~30.9' / 2.5 Stories	Yes
Max Coverage Imperv Surface		N/A	N/A	N/A	N/A
Max. Impervious (front yard)		N/A	N/A	No Change	N/A
Min. Open Space		N/A	N/A	N/A	N/A
Max. width of principal structure		N/A	N/A	No Change	Yes
Max Impervious surfaces		N/A	N/A	N/A	Yes

T-1	TITLE SHEET
A-0	BASEMENT FLOOR PLANS
A-1	ENTRY FLOOR PLANS
A-2	SECOND LEVEL
A-3	ROOF PLAN
A-3	EXTERIOR ELEVATIONS
A-4	EXTERIOR ELEVATIONS
A-5	WALL AND BUILDING SECTIONS
E-1	ELECTRICAL AND LIGHTING PLAN (BASEMENT + FIRST FLOOR)
E-2	ELECTRICAL AND LIGHTING PLAN (SECOND FLOOR)
P-1	PLUMBING RISER DIAGRAM AND SUPPLY DIAGRAM

NEW 2-STORY ADDITION TO THE BACK OF AN EXISTING 2 STORY HOUSE / THIS IS AN ALTERATION AND ADDITION.

BASEMENT
BUILD NEW FULL HEIGHT BASEMENT UNDER NEW 2 STORY ADDITION. THERE WILL BE ACCESS TO THE NEW BASEMENT FROM THE EXISTING LAUNDRY ROOM. AND FROM THE OUTSIDE THROUGH THE NEW BILCO DOORS.

THE KITCHEN WILL BE REMODELED. IN THE NEW ADDITION THERE WILL BE A NEW FAMILY ROOM , NEW DECK, AND NEW BEDROOM SUITE.

SECOND FLOOR
BATHROOM #1 WILL BE REMODELED. IN THE NEW ADDITION THERE WILL BE A NEW MASTER BEDROOM, NEW MASTER CLOSET, AND NEW MASTER BATHROOM.

SITE PLAN

**LOT 4
BLOCK 4501
AREA=0.238± AC.**

EXISTING HOUSE

NEW 2-STORY ADDITION

NEW DECK

NEW BILCO DOOR WITH STAIR TO BASEMENT

CONC. BLOCK PAVERS

ADJ. GARAGE

GARAGE

WOOD FENCE

VINYL FENCE

CHAIN LINK FENCE

FENCE ON LINE

U.P.

ASPHALT

CONC. WALK

BLOCK CURB

SLATE

ADJ. CONC.

CONC.

ADJ. GARAGE

DRIVEWAY TO BE UPDATED. NEW PART OF DRIVEWAY TO BE SETBACK 4' PER ZONING ORDINANCE.

60'-7"

70'-7"

60'-7"

70'-7"

7.8'

7.7'

39.7'

39.7'

16'-0"

4'-0"

1.1'

1.6'

0.5'

0.6'

S23°00'00"W 70.00'

S67°00'00"E 148.00'

N67°00'00"W 148.00'

N123°00'00"E


Deed Book 5359, Page 384

REVISION S	B Y

the 1990s, the number of people in the United States who are 65 years of age or older has increased by 50 percent. The number of people 75 years of age or older has increased by 100 percent. The number of people 85 years of age or older has increased by 200 percent. The number of people 95 years of age or older has increased by 400 percent. The number of people 100 years of age or older has increased by 1,000 percent. The number of people 105 years of age or older has increased by 2,000 percent. The number of people 110 years of age or older has increased by 4,000 percent. The number of people 115 years of age or older has increased by 8,000 percent. The number of people 120 years of age or older has increased by 16,000 percent. The number of people 125 years of age or older has increased by 32,000 percent. The number of people 130 years of age or older has increased by 64,000 percent. The number of people 135 years of age or older has increased by 128,000 percent. The number of people 140 years of age or older has increased by 256,000 percent. The number of people 145 years of age or older has increased by 512,000 percent. The number of people 150 years of age or older has increased by 1,024,000 percent. The number of people 155 years of age or older has increased by 2,048,000 percent. The number of people 160 years of age or older has increased by 4,096,000 percent. The number of people 165 years of age or older has increased by 8,192,000 percent. The number of people 170 years of age or older has increased by 16,384,000 percent. The number of people 175 years of age or older has increased by 32,768,000 percent. The number of people 180 years of age or older has increased by 65,536,000 percent. The number of people 185 years of age or older has increased by 131,072,000 percent. The number of people 190 years of age or older has increased by 262,144,000 percent. The number of people 195 years of age or older has increased by 524,288,000 percent. The number of people 200 years of age or older has increased by 1,048,576,000 percent. The number of people 205 years of age or older has increased by 2,097,152,000 percent. The number of people 210 years of age or older has increased by 4,194,304,000 percent. The number of people 215 years of age or older has increased by 8,388,608,000 percent. The number of people 220 years of age or older has increased by 16,777,216,000 percent. The number of people 225 years of age or older has increased by 33,554,432,000 percent. The number of people 230 years of age or older has increased by 67,108,864,000 percent. The number of people 235 years of age or older has increased by 134,217,728,000 percent. The number of people 240 years of age or older has increased by 268,435,456,000 percent. The number of people 245 years of age or older has increased by 536,870,912,000 percent. The number of people 250 years of age or older has increased by 1,073,741,824,000 percent. The number of people 255 years of age or older has increased by 2,147,483,648,000 percent. The number of people 260 years of age or older has increased by 4,294,967,296,000 percent. The number of people 265 years of age or older has increased by 8,589,934,592,000 percent. The number of people 270 years of age or older has increased by 17,179,869,184,000 percent. The number of people 275 years of age or older has increased by 34,359,738,368,000 percent. The number of people 280 years of age or older has increased by 68,719,476,736,000 percent. The number of people 285 years of age or older has increased by 137,438,953,472,000 percent. The number of people 290 years of age or older has increased by 274,877,906,944,000 percent. The number of people 295 years of age or older has increased by 549,755,813,888,000 percent. The number of people 300 years of age or older has increased by 1,099,511,627,776,000 percent. The number of people 305 years of age or older has increased by 2,199,023,255,552,000 percent. The number of people 310 years of age or older has increased by 4,398,046,511,104,000 percent. The number of people 315 years of age or older has increased by 8,796,093,022,208,000 percent. The number of people 320 years of age or older has increased by 17,592,186,044,416,000 percent. The number of people 325 years of age or older has increased by 35,184,372,088,832,000 percent. The number of people 330 years of age or older has increased by 70,368,744,177,664,000 percent. The number of people 335 years of age or older has increased by 140,737,488,355,328,000 percent. The number of people 340 years of age or older has increased by 281,474,976,710,656,000 percent. The number of people 345 years of age or older has increased by 562,949,953,421,312,000 percent. The number of people 350 years of age or older has increased by 1,125,899,906,842,624,000 percent. The number of people 355 years of age or older has increased by 2,251,799,813,685,248,000 percent. The number of people 360 years of age or older has increased by 4,503,599,627,370,496,000 percent. The number of people 365 years of age or older has increased by 9,007,199,254,740,992,000 percent. The number of people 370 years of age or older has increased by 18,014,398,509,481,984,000 percent. The number of people 375 years of age or older has increased by 36,028,797,018,963,968,000 percent. The number of people 380 years of age or older has increased by 72,057,594,037,927,936,000 percent. The number of people 385 years of age or older has increased by 144,115,188,075,855,872,000 percent. The number of people 390 years of age or older has increased by 288,230,376,151,711,744,000 percent. The number of people 395 years of age or older has increased by 576,460,752,303,423,488,000 percent. The number of people 400 years of age or older has increased by 1,152,921,504,606,846,976,000 percent. The number of people 405 years of age or older has increased by 2,305,843,009,213,693,952,000 percent. The number of people 410 years of age or older has increased by 4,611,686,018,427,387,904,000 percent. The number of people 415 years of age or older has increased by 9,223,372,036,854,775,808,000 percent. The number of people 420 years of age or older has increased by 18,446,744,073,709,551,616,000 percent. The number of people 425 years of age or older has increased by 36,893,488,147,419,103,232,000 percent. The number of people 430 years of age or older has increased by 73,786,976,294,838,206,464,000 percent. The number of people 435 years of age or older has increased by 147,573,952,589,676,412,928,000 percent. The number of people 440 years of age or older has increased by 295,147,905,179,352,825,856,000 percent. The number of people 445 years of age or older has increased by 590,295,810,358,705,651,712,000 percent. The number of people 450 years of age or older has increased by 1,180,591,620,717,411,303,424,000 percent. The number of people 455 years of age or older has increased by 2,361,183,241,434,822,606,848,000 percent. The number of people 460 years of age or older has increased by 4,722,366,482,869,645,213,696,000 percent. The number of people 465 years of age or older has increased by 9,444,732,965,739,290,427,392,000 percent. The number of people 470 years of age or older has increased by 18,889,465,931,478,580,854,784,000 percent. The number of people 475 years of age or older has increased by 37,778,931,862,957,161,709,568,000 percent. The number of people 480 years of age or older has increased by 75,557,863,725,914,323,419,136,000 percent. The number of people 485 years of age or older has increased by 151,115,727,451,828,646,838,272,000 percent. The number of people 490 years of age or older has increased by 302,231,454,903,657,293,676,544,000 percent. The number of people 495 years of age or older has increased by 604,462,909,807,314,587,353,088,000 percent. The number of people 500 years of age or older has increased by 1,208,925,819,614,629,174,706,176,000 percent. The number of people 505 years of age or older has increased by 2,417,851,639,229,258,349,412,352,000 percent. The number of people 510 years of age or older has increased by 4,835,703,278,458,516,698,824,704,000 percent. The number of people 515 years of age or older has increased by 9,671,406,556,917,033,397,649,408,000 percent. The number of people 520 years of age or older has increased by 19,342,813,113,834,066,795,298,816,000 percent. The number of people 525 years of age or older has increased by 38,685,626,227,668,133,590,597,632,000 percent. The number of people 530 years of age or older has increased by 77,371,252,455,336,267,181,195,264,000 percent. The number of people 535 years of age or older has increased by 154,742,504,910,672,534,362,390,528,000 percent. The number of people 540 years of age or older has increased by 309,485,009,821,345,068,724,781,056,000 percent. The number of people 545 years of age or older has increased by 618,970,019,642,690,137,449,562,112,000 percent. The number of people 550 years of age or older has increased by 1,237,940,039,285,380,274,899,124,224,000 percent. The number of people 555 years of age or older has increased by 2,475,880,078,570,760,549,798,248,448,000 percent. The number of people 560 years of age or older has increased by 4,951,760,157,141,521,099,596,496,896,000 percent. The number of people 565 years of age or older has increased by 9,903,520,314,283,042,199,193,993,792,000 percent. The number of people 570 years of age or older has increased by 19,807,040,628,566,084,398,387,9

DRAWN	CHECKED
DATE	
SCALE	1" = 10'-0"
JOB	
HWG	06.28.2019
SHEET	


T-1

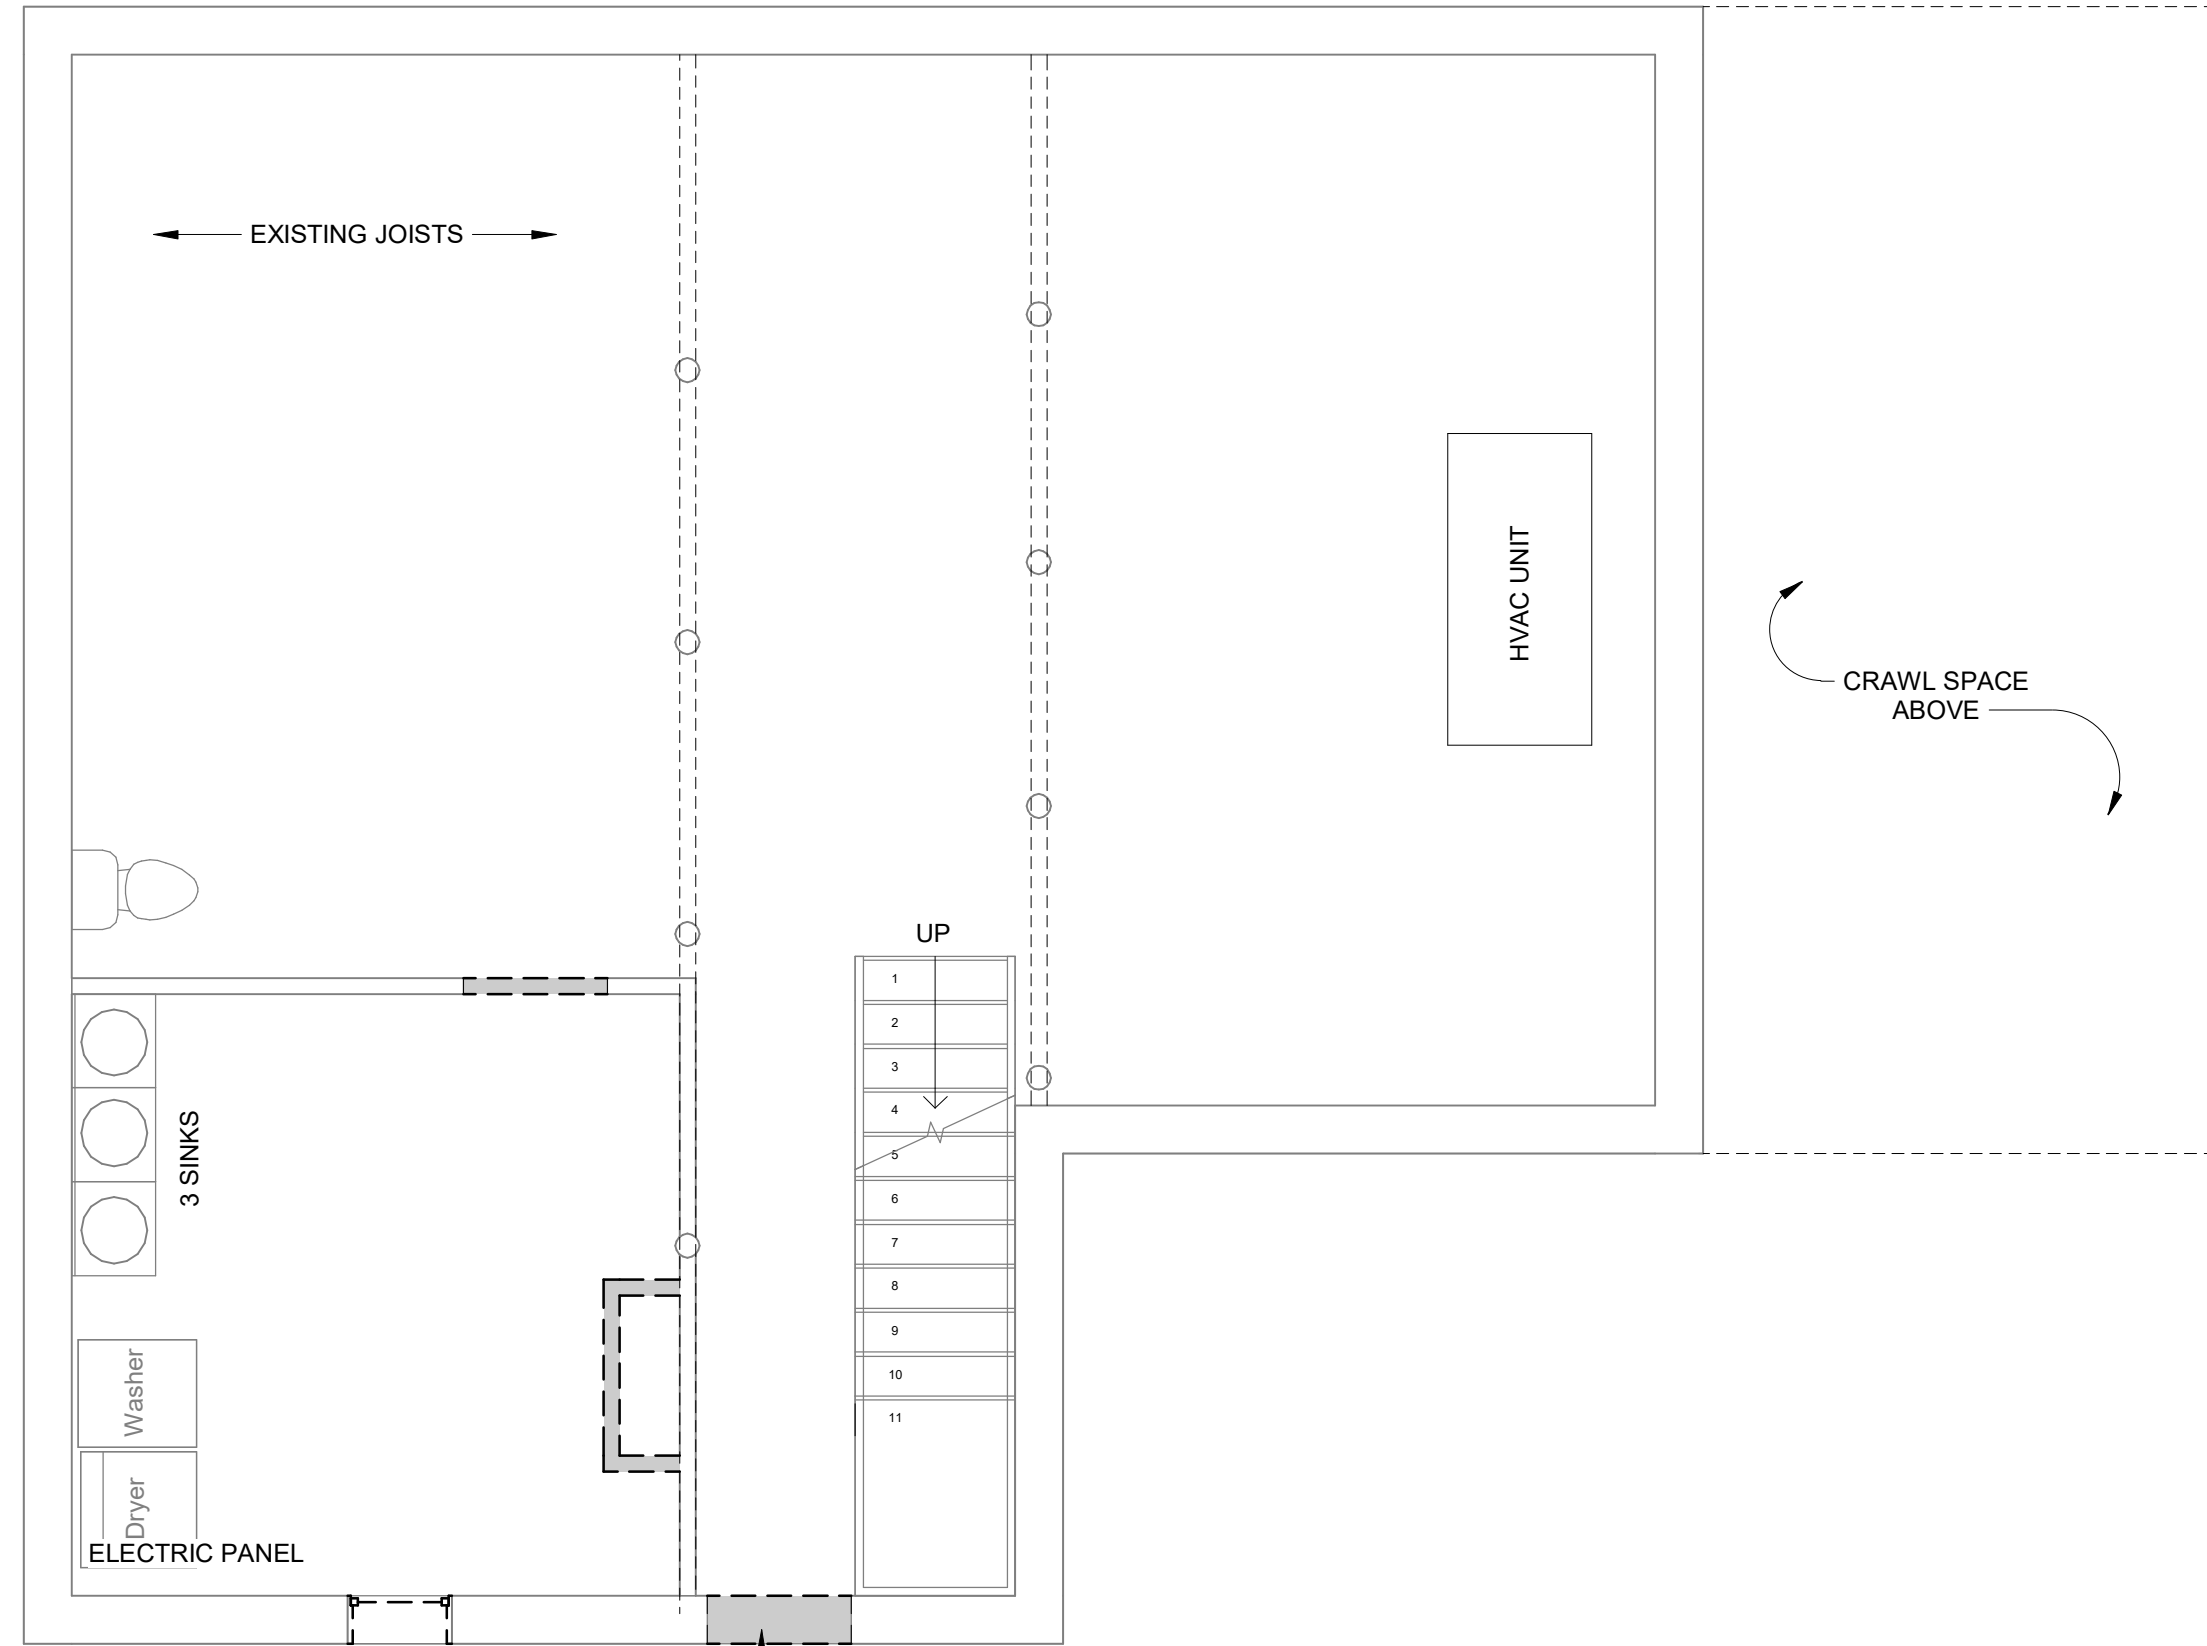

1 Existing - Basement Floor
1/4" = 1'-0"

PLAN NOTES:

1. All dimensions and wall locations are depicted as accurately as site conditions would allow via visual inspection
2. Dimensions provided are to face of finish, unless noted otherwise.
4. All new electric to match existing unless noted otherwise
5. Coordinate repair or selection and installation of mechanical equipment (furnace, water heater, etc.) with hvac contractor
6. Consult with architect for any deficiencies (I.E. Excessive notching or cutting of structural members, etc.) uncovered not identified on drawings.

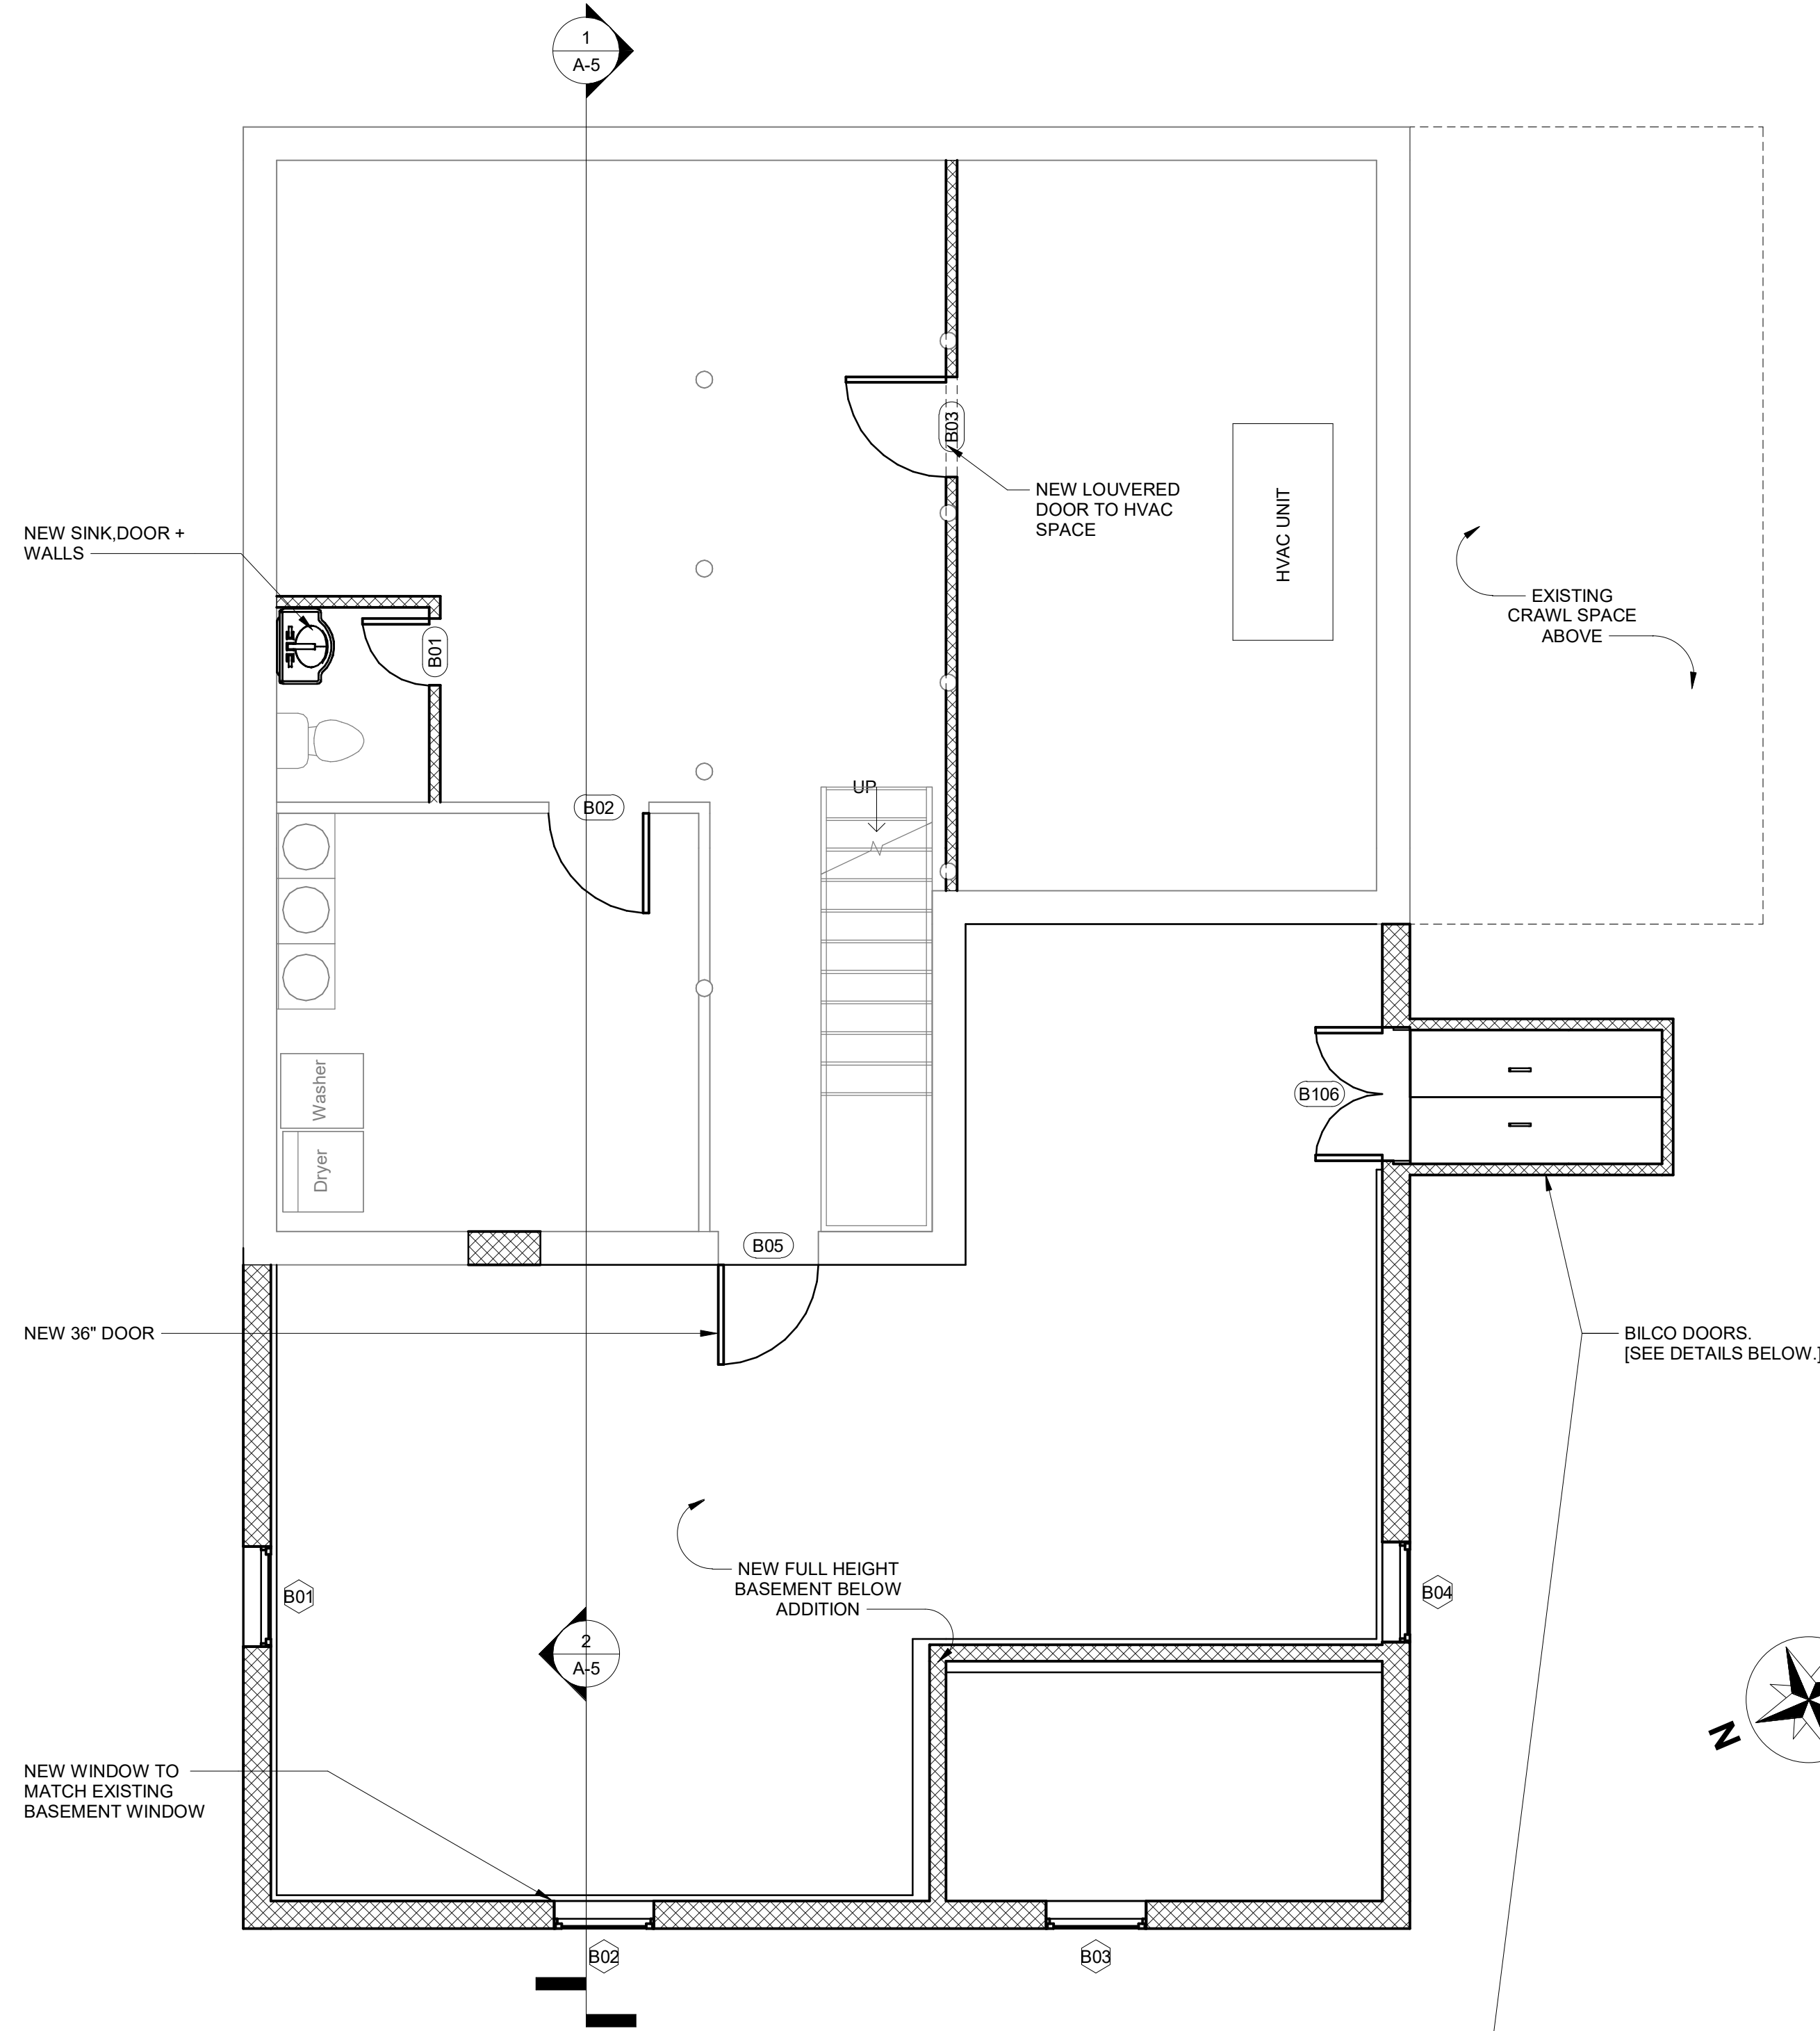

2 Proposed - Basement Floor
1/4" = 1'-0"

BILCO DOOR AND STAIR DETAIL

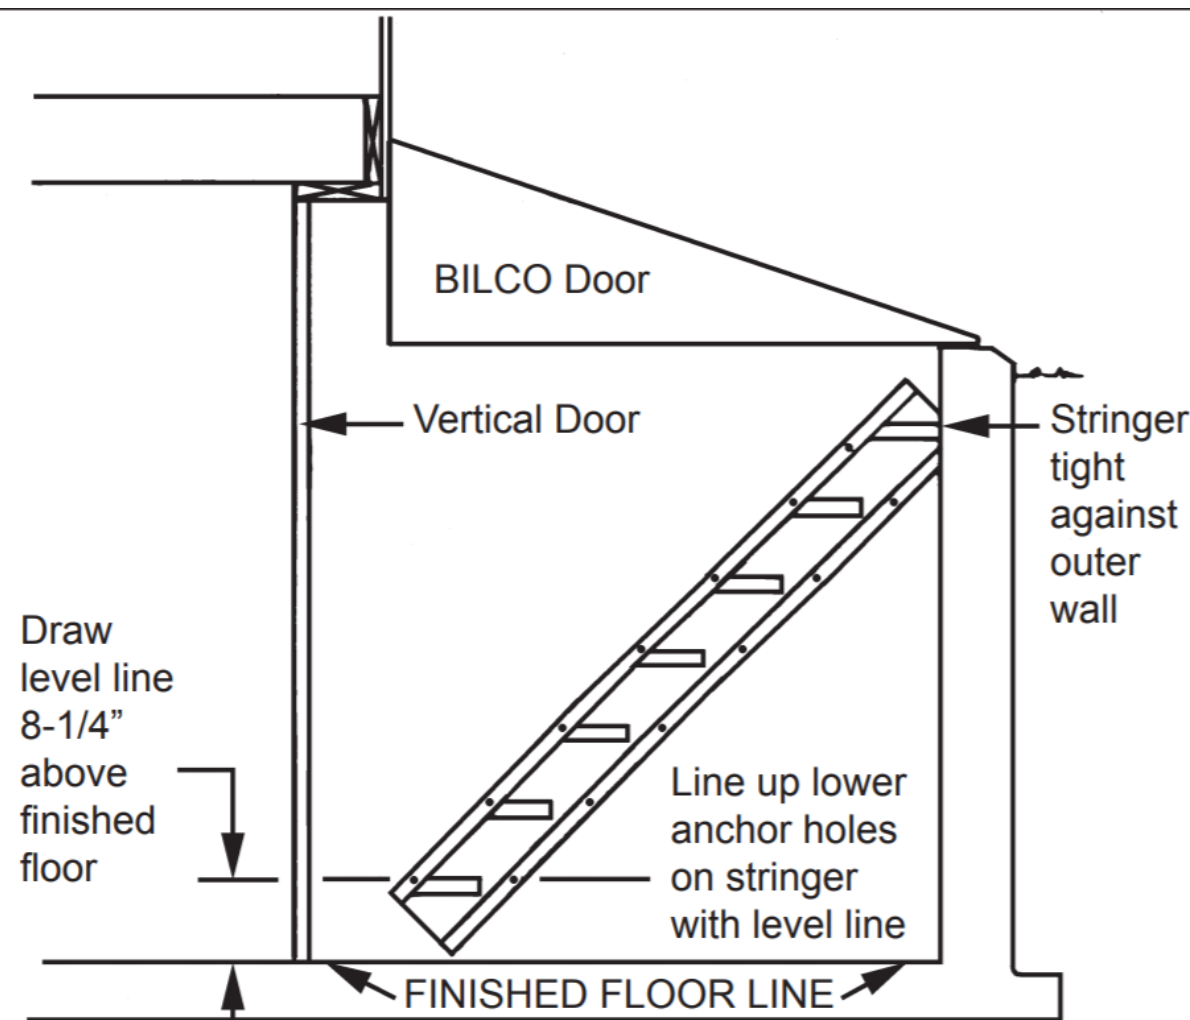


Figure 1


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DATE	
SCALE	1/4" = 1'-0"
JOB	
DWG	06.28.2019
SHEET	


A-0

Door Schedule				
Mark	Width	Height	Description	Level
B05	3' - 0"	6' - 8"	Single	Basement Floor
B01	2' - 0"	6' - 8"		Basement Floor
B03	3' - 0"	6' - 8"	Single	Basement Floor
B02	3' - 0"	6' - 8"	Single	Basement Floor
B106	4' - 0"	6' - 8"	Double Flush Panel	Basement Floor
07	2' - 6"	6' - 8"	Single	First Floor
06	2' - 6"	6' - 8"	Single	First Floor
05	2' - 4"	6' - 8"	Single	First Floor
04	3' - 6"	7' - 0"		First Floor
03	4' - 0"	6' - 8"	Double Flush Panel	First Floor
08	2' - 2"	6' - 8"	Single	First Floor
02	4' - 10"	6' - 8"	Double Sliding	First Floor
01	3' - 0"	6' - 8"	Single	First Floor
B108	1' - 8"	6' - 8"		First Floor
12	2' - 4"	6' - 8"	Single	Second Floor
11	6' - 0"	6' - 8"	Bi-Fold_Panel	Second Floor
13	2' - 2"	6' - 8"	Single	Second Floor
09	2' - 8"	6' - 8"	Single	Second Floor
10	2' - 8"	6' - 8"	Single	Second Floor
08	2' - 8"	6' - 8"	Single	Second Floor
18	4' - 0"	6' - 8"	Double Flush Panel	Second Floor
17	4' - 0"	6' - 8"	Double Flush Panel	Second Floor
14	2' - 4"	6' - 8"	Single	Second Floor
16	2' - 4"	6' - 8"	Single	Second Floor
15	2' - 6"	6' - 8"		Second Floor
B107	2' - 4"	6' - 8"	Single	Second Floor

Window Schedule						
Mark	Width	Height	Head Height	Family	Comments	Level
B01	3' - 0"	2' - 0"	6' - 11"	Window-Awni ng-Single		Basement Floor
B03	3' - 0"	2' - 0"	6' - 11"	Window-Awni ng-Single		Basement Floor
B02	3' - 0"	2' - 0"	6' - 11"	Window-Awni ng-Single		Basement Floor
B04	3' - 0"	2' - 0"	6' - 11"	Window-Awni ng-Single		Basement Floor
05	2' - 11"	4' - 6"	6' - 8"	Double Hung		First Floor
04	2' - 11"	4' - 6"	6' - 8"	Double Hung		First Floor
01	2' - 9"	3' - 10"	6' - 8"	Double Hung		First Floor
03	2' - 11"	4' - 6"	6' - 8"	Double Hung		First Floor
02	2' - 11"	4' - 6"	6' - 8"	Double Hung		First Floor
07	2' - 11"	4' - 6"	6' - 8"	Double Hung		First Floor
06	2' - 11"	4' - 6"	6' - 8"	Double Hung		First Floor
09	2' - 11"	4' - 6"	6' - 8"	Double Hung		First Floor
08	4' - 10"	4' - 6"	6' - 8"	Fixed		First Floor
12	2' - 8"	4' - 4"	6' - 8"	Double Hung		Second Floor
13	2' - 8"	4' - 4"	6' - 8"	Double Hung		Second Floor
17	2' - 8"	4' - 4"	6' - 8"	Double Hung		Second Floor
15	2' - 8"	4' - 4"	6' - 8"	Double Hung		Second Floor
16	4' - 10"	4' - 4"	6' - 8"	Fixed		Second Floor
14	2' - 8"	4' - 4"	6' - 8"	Double Hung		Second Floor
11	2' - 8"	4' - 4"	6' - 8"	Double Hung		Second Floor

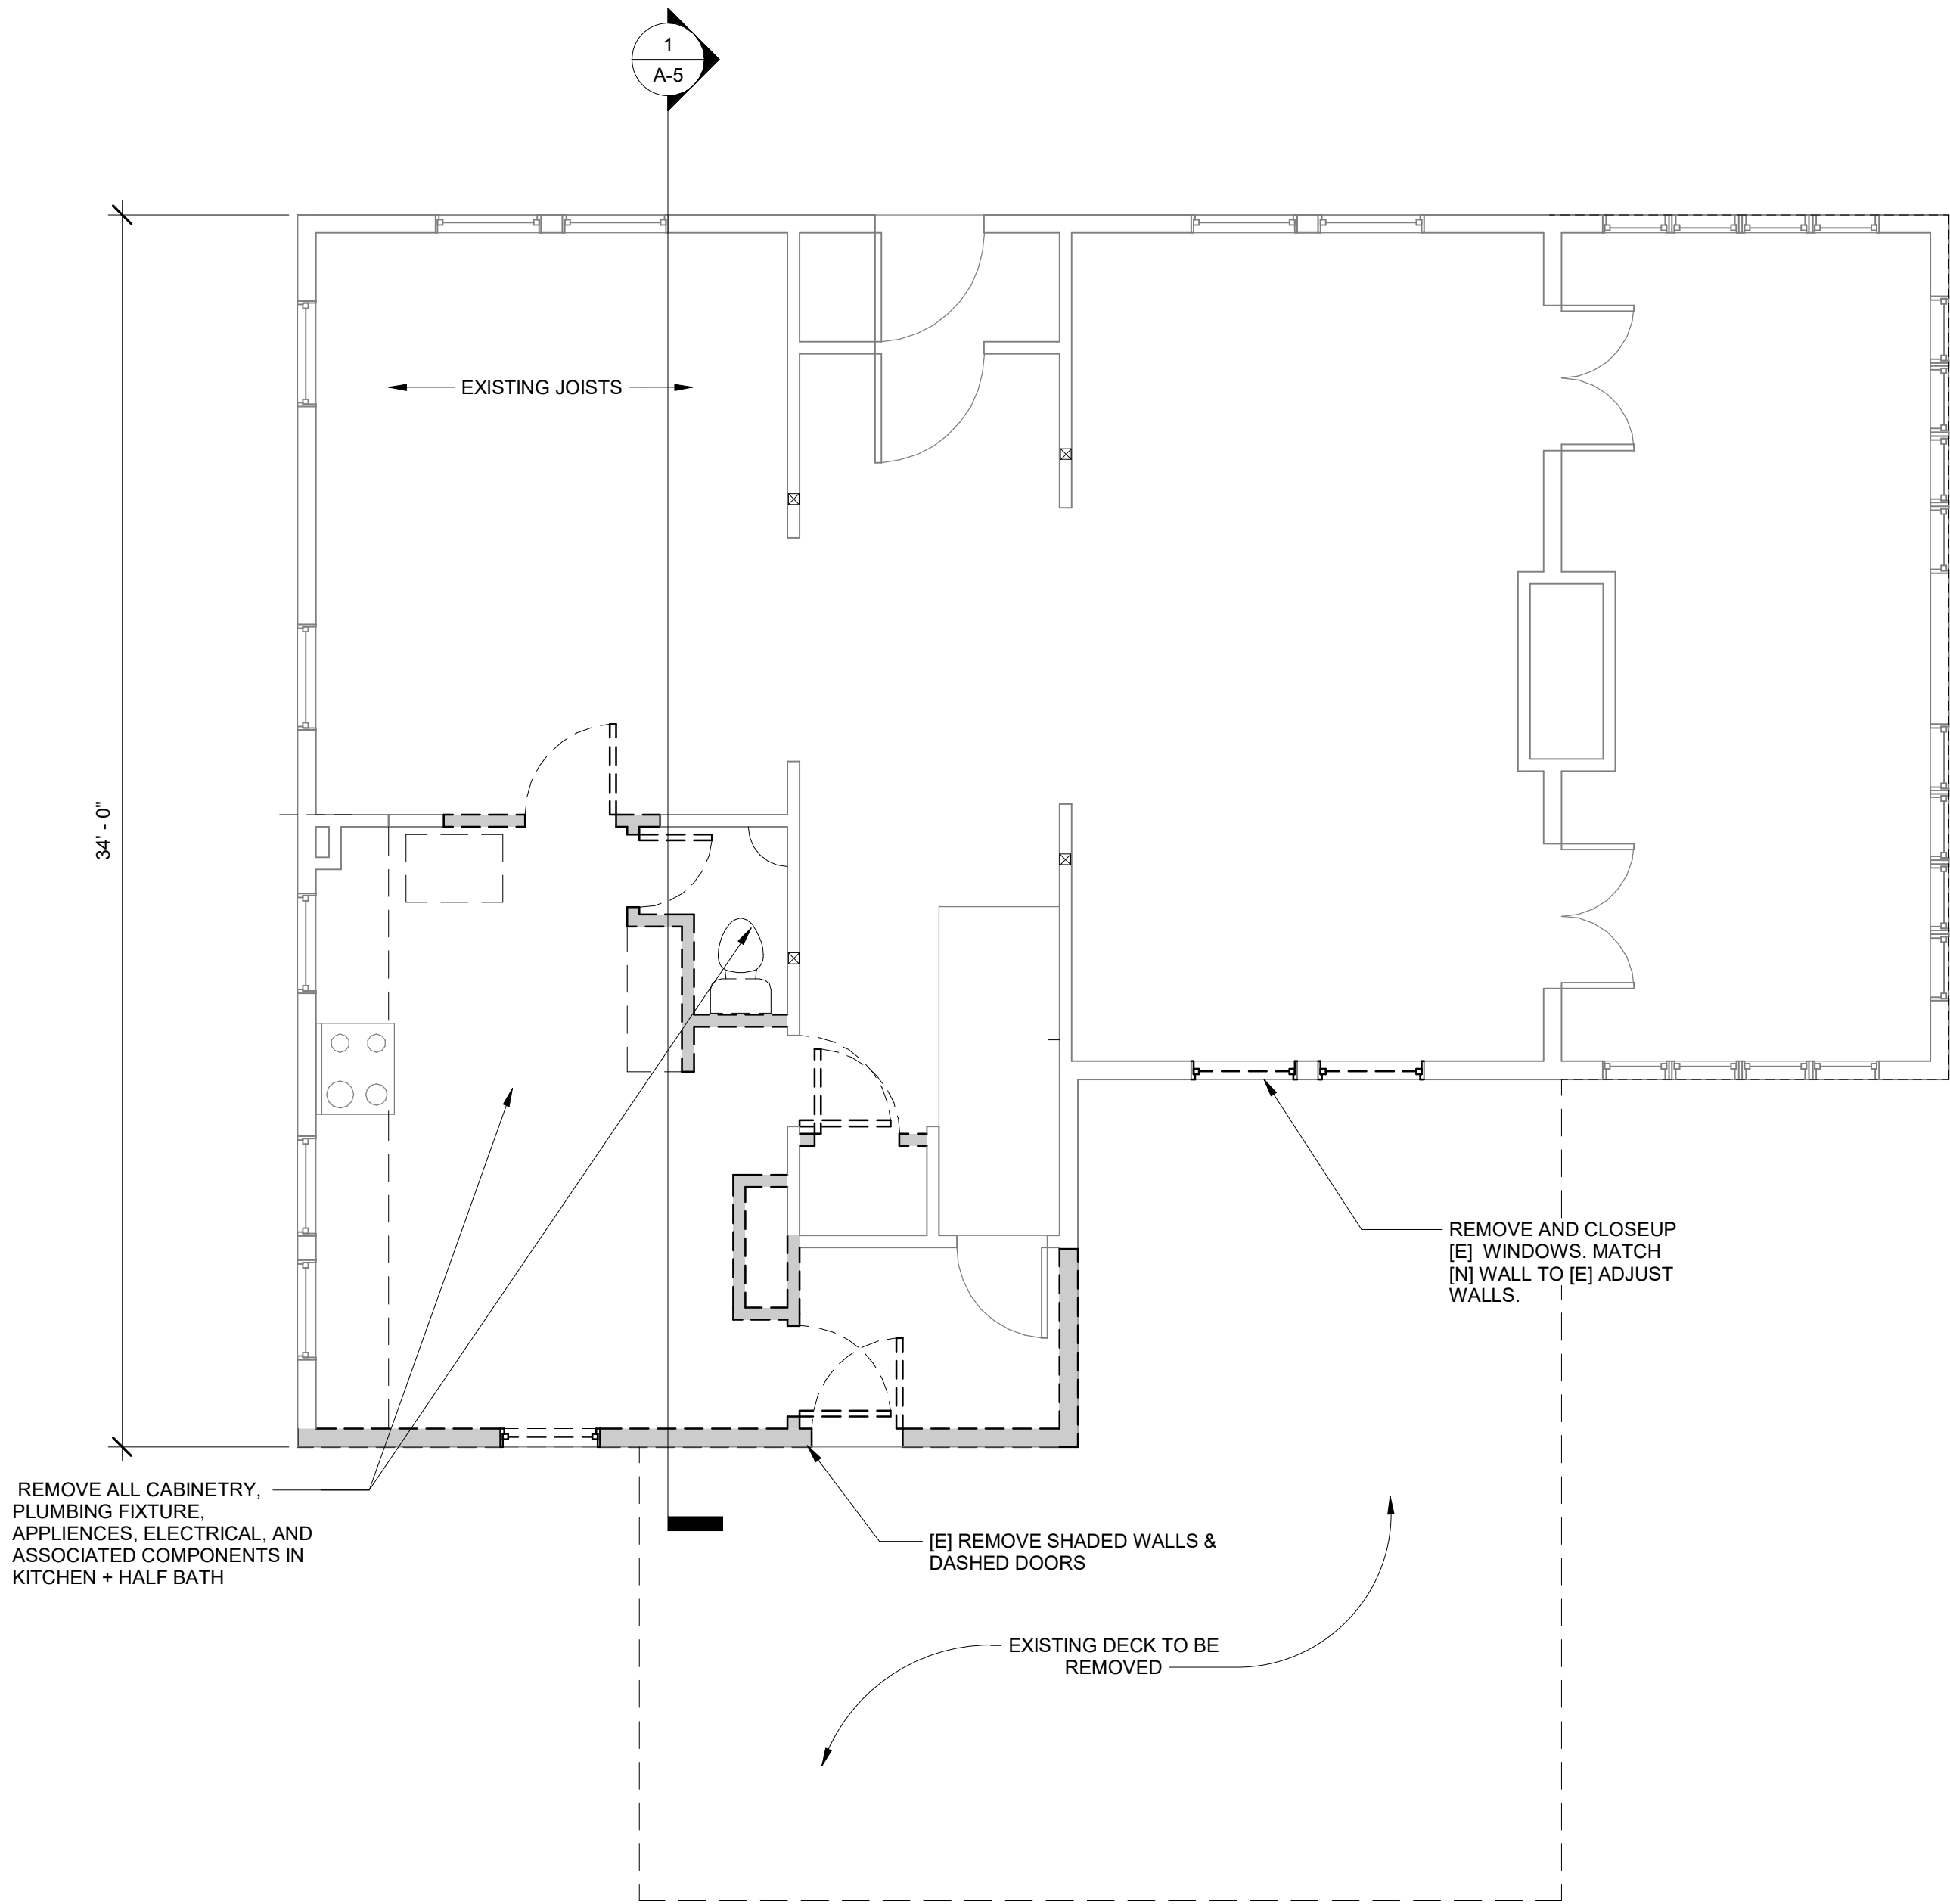

1 Existing + Demo - Entry Floor
1/4" = 1'-0"

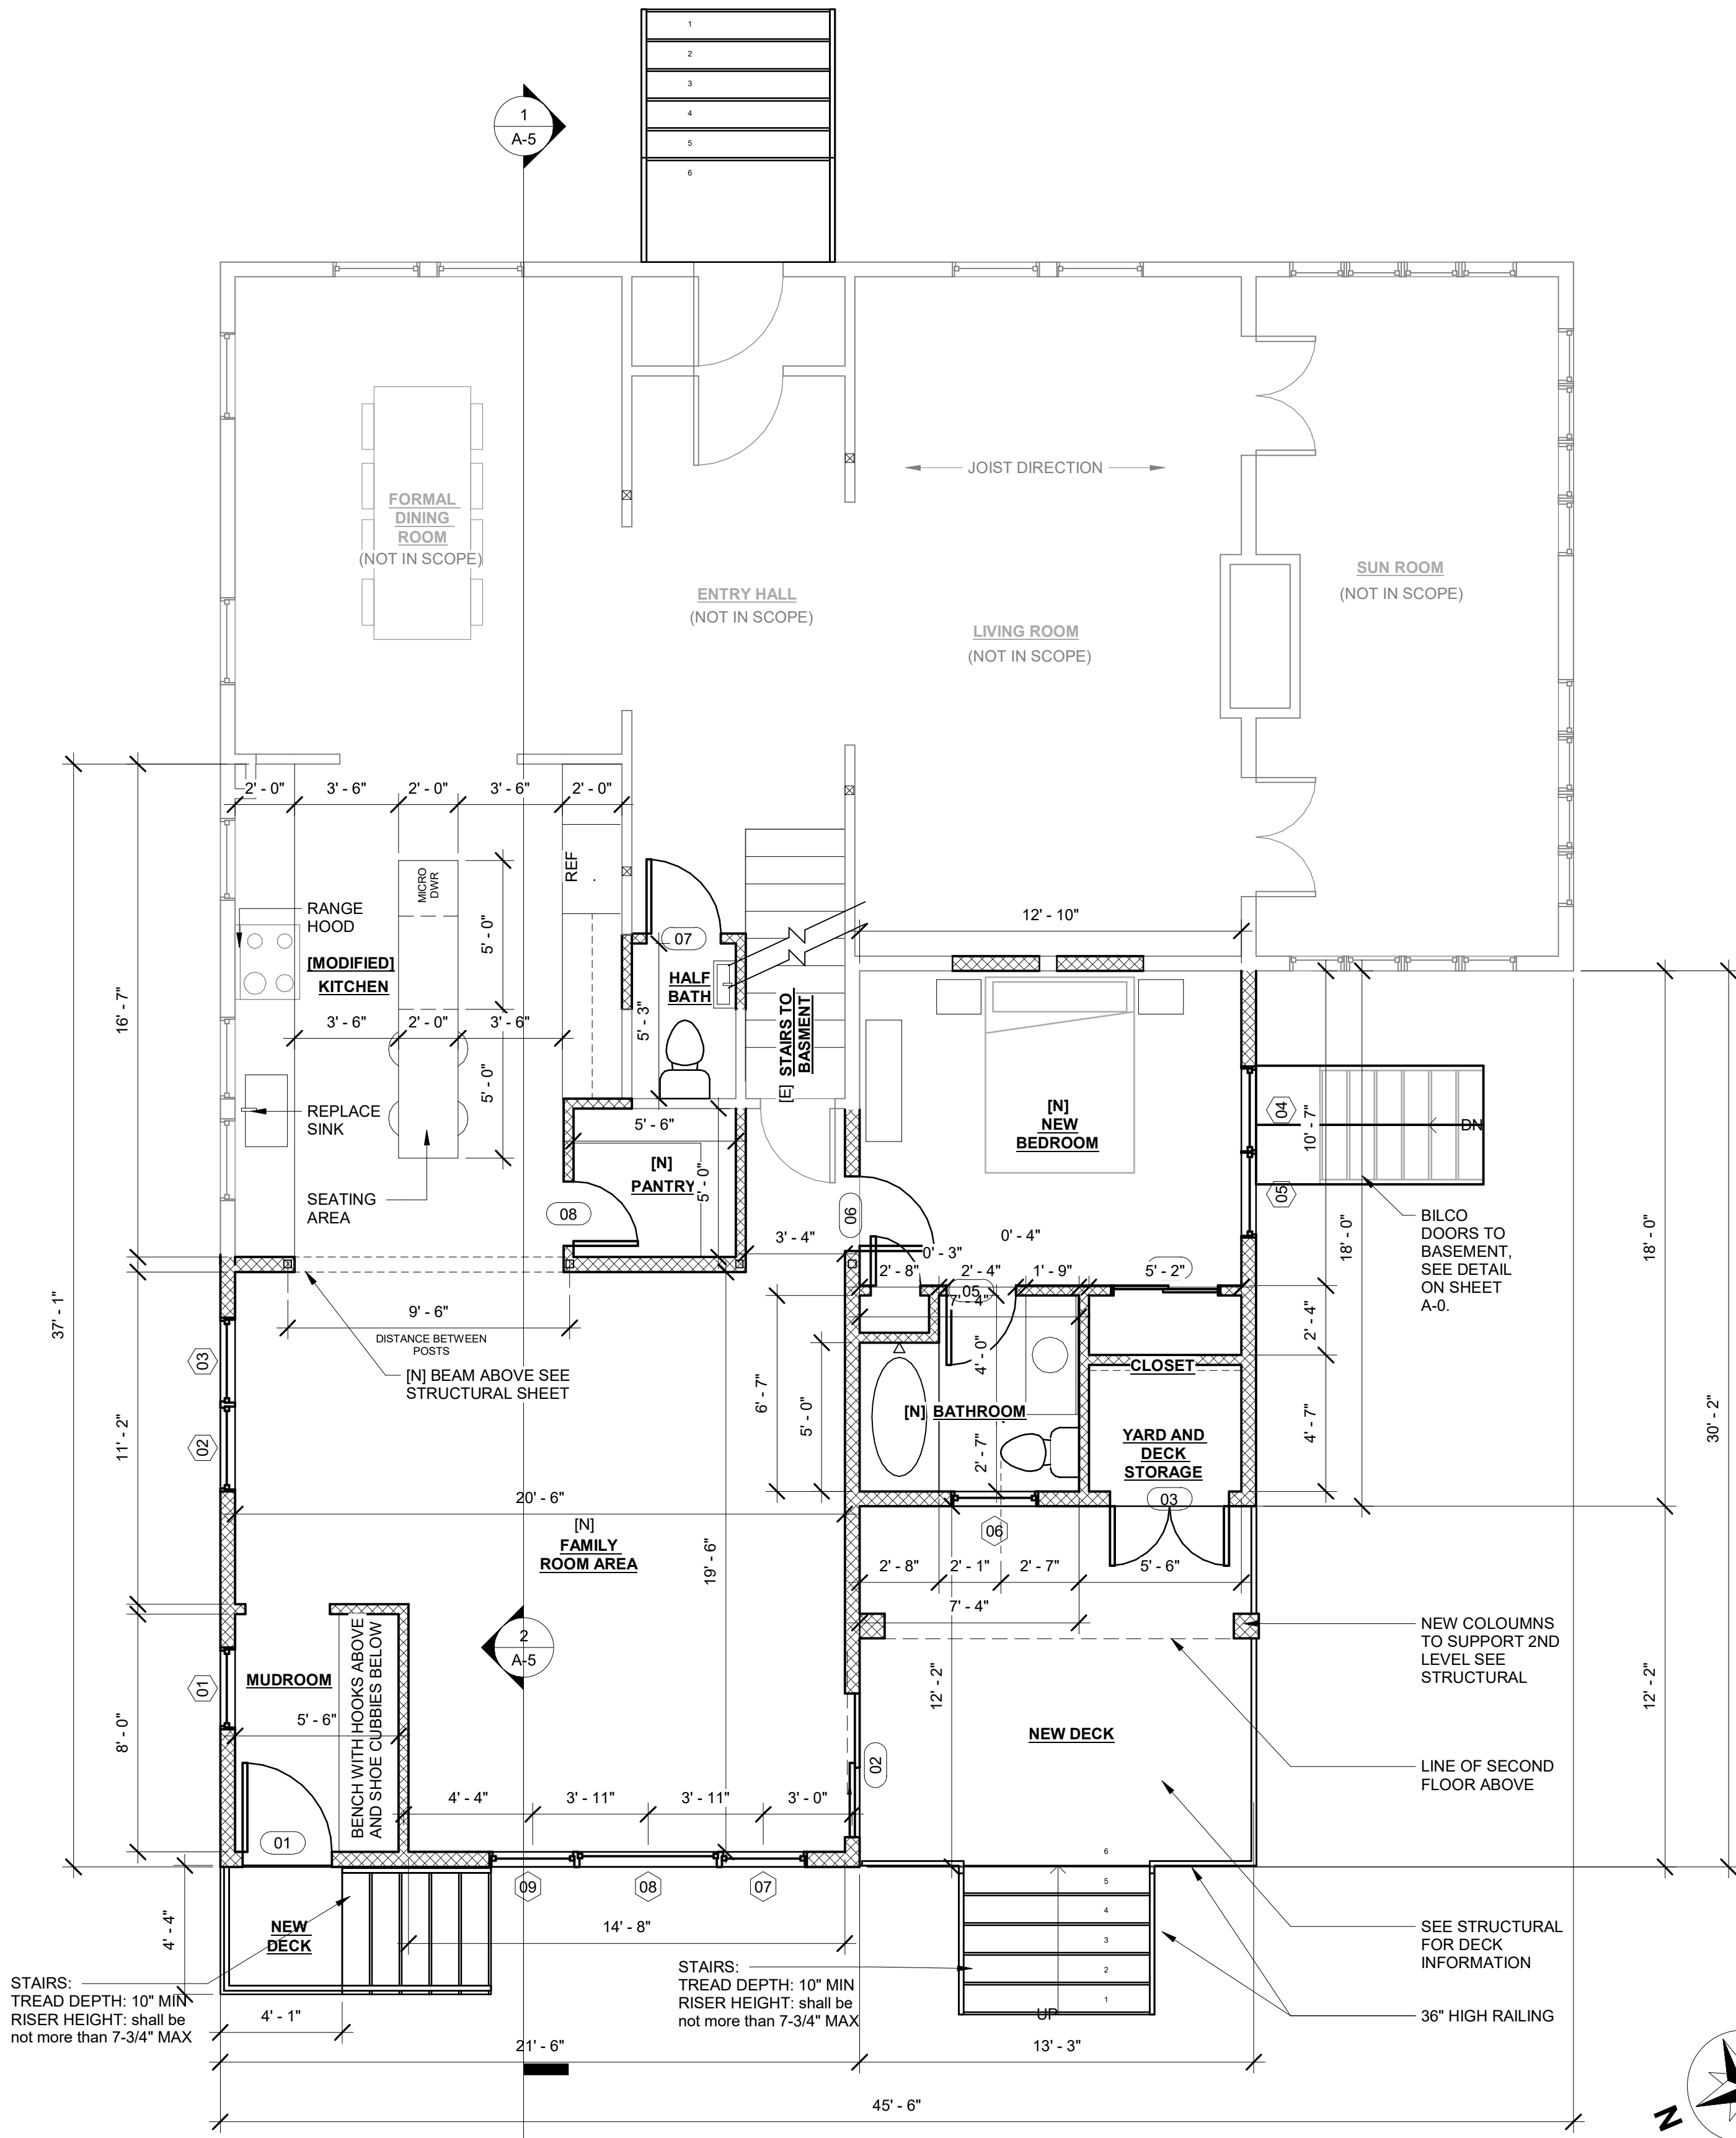

2 Proposed - Entry Floor
1/4" = 1'-0"

FIRST FLOOR PLAN

NOTES:


1. All dimensions and wall locations are depicted as accurately as site conditions would allow via visual inspection
2. Dimensions provided are to face of finish, unless noted otherwise.
3. All new electric to match existing unless noted otherwise
4. All new electric to match existing unless noted otherwise
5. Coordinate repair or selection and installation of mechanical equipment (furnace, water heater, etc.) with hvac contractor
6. Consult with architect for any deficiencies (I.E. Excessive notching or cutting of structural members, etc.) uncovered not identified on drawings
7. Where gypsum board wall finish is to be installed beneath bathroom, gypsum board shall be moisture resistant, mold resistant "Green" gypsum board.
8. Provide plywood blocking, wood blocking, or galvanized metal strapping at all locations to receive wall mounted cabinets, shelves or tv monitors. Coordinate blocking / strapping with exact locations of millwork to be installed.

WALL LEGEND

- EXISTING WALL
- NEW 2x6 WOOD FRAMED WALL W/ 1/2" GYP EACH SIDE
- EXISTING WALL TO BE DEMOLISHED

REVISION	B
S	Y

DRAWN	CHECKED
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SCALE	1/4" = 1'-0"
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DWG	06.28.2019
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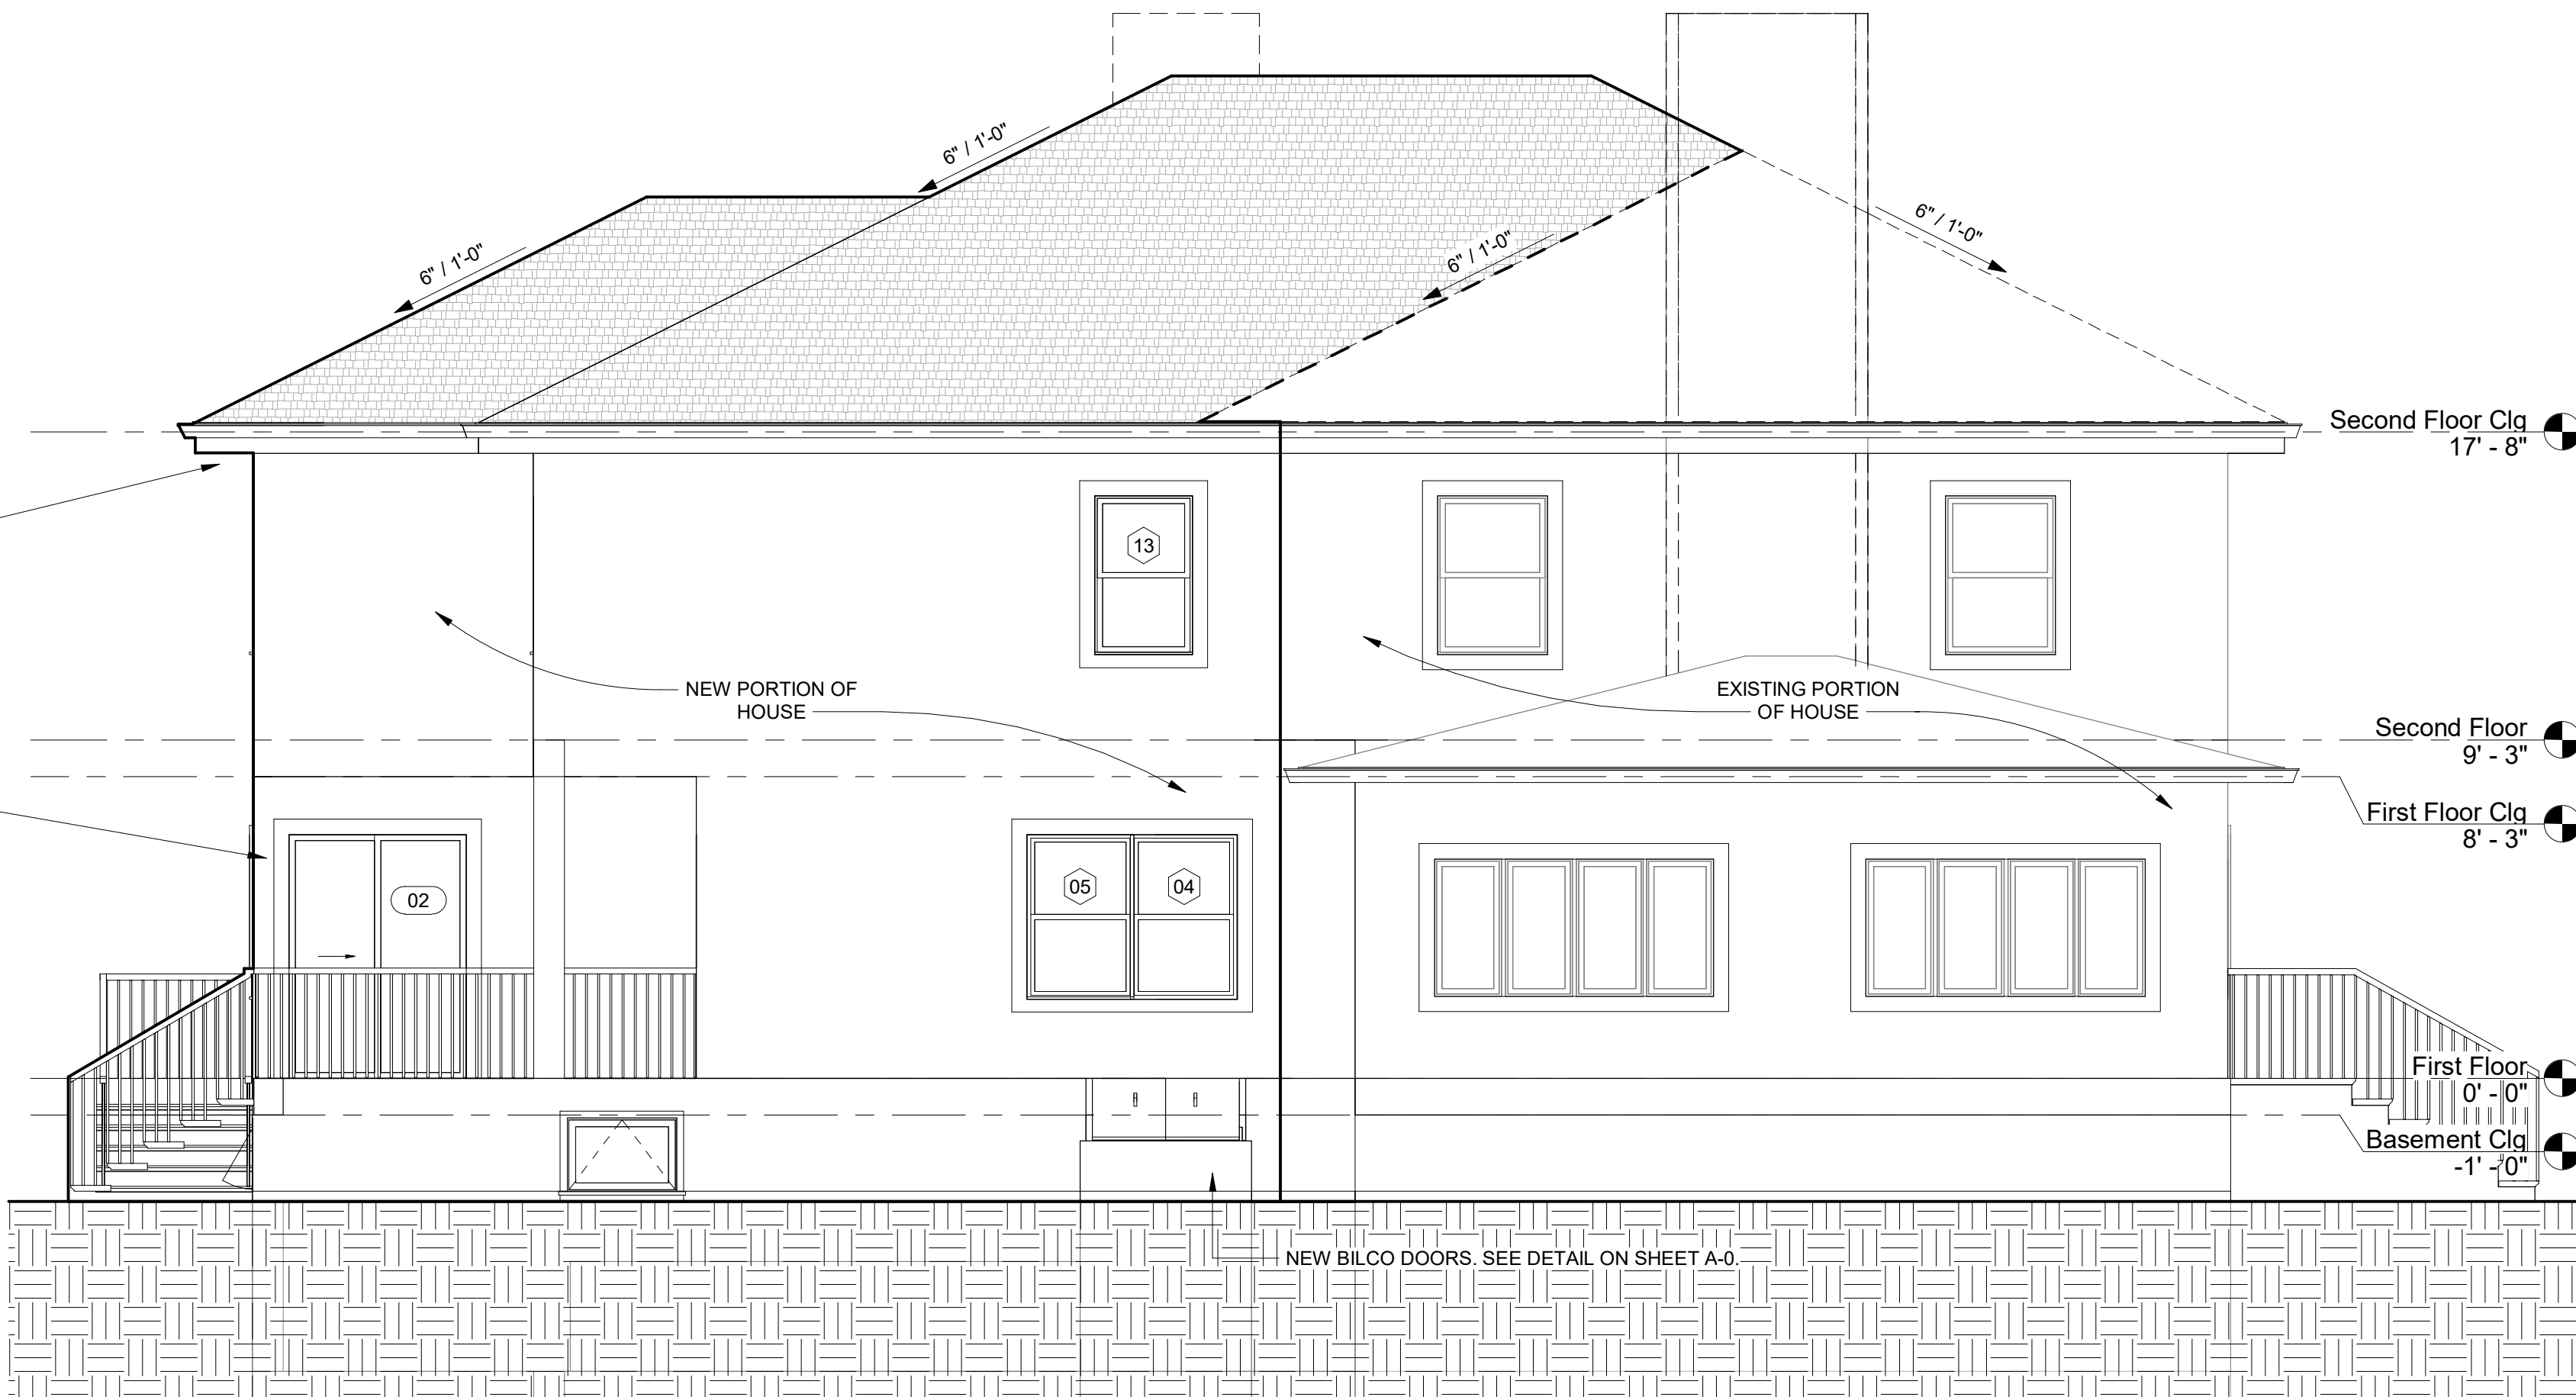
1 PROPOSED NORTH ELEVATION
1/4" = 1'-0"

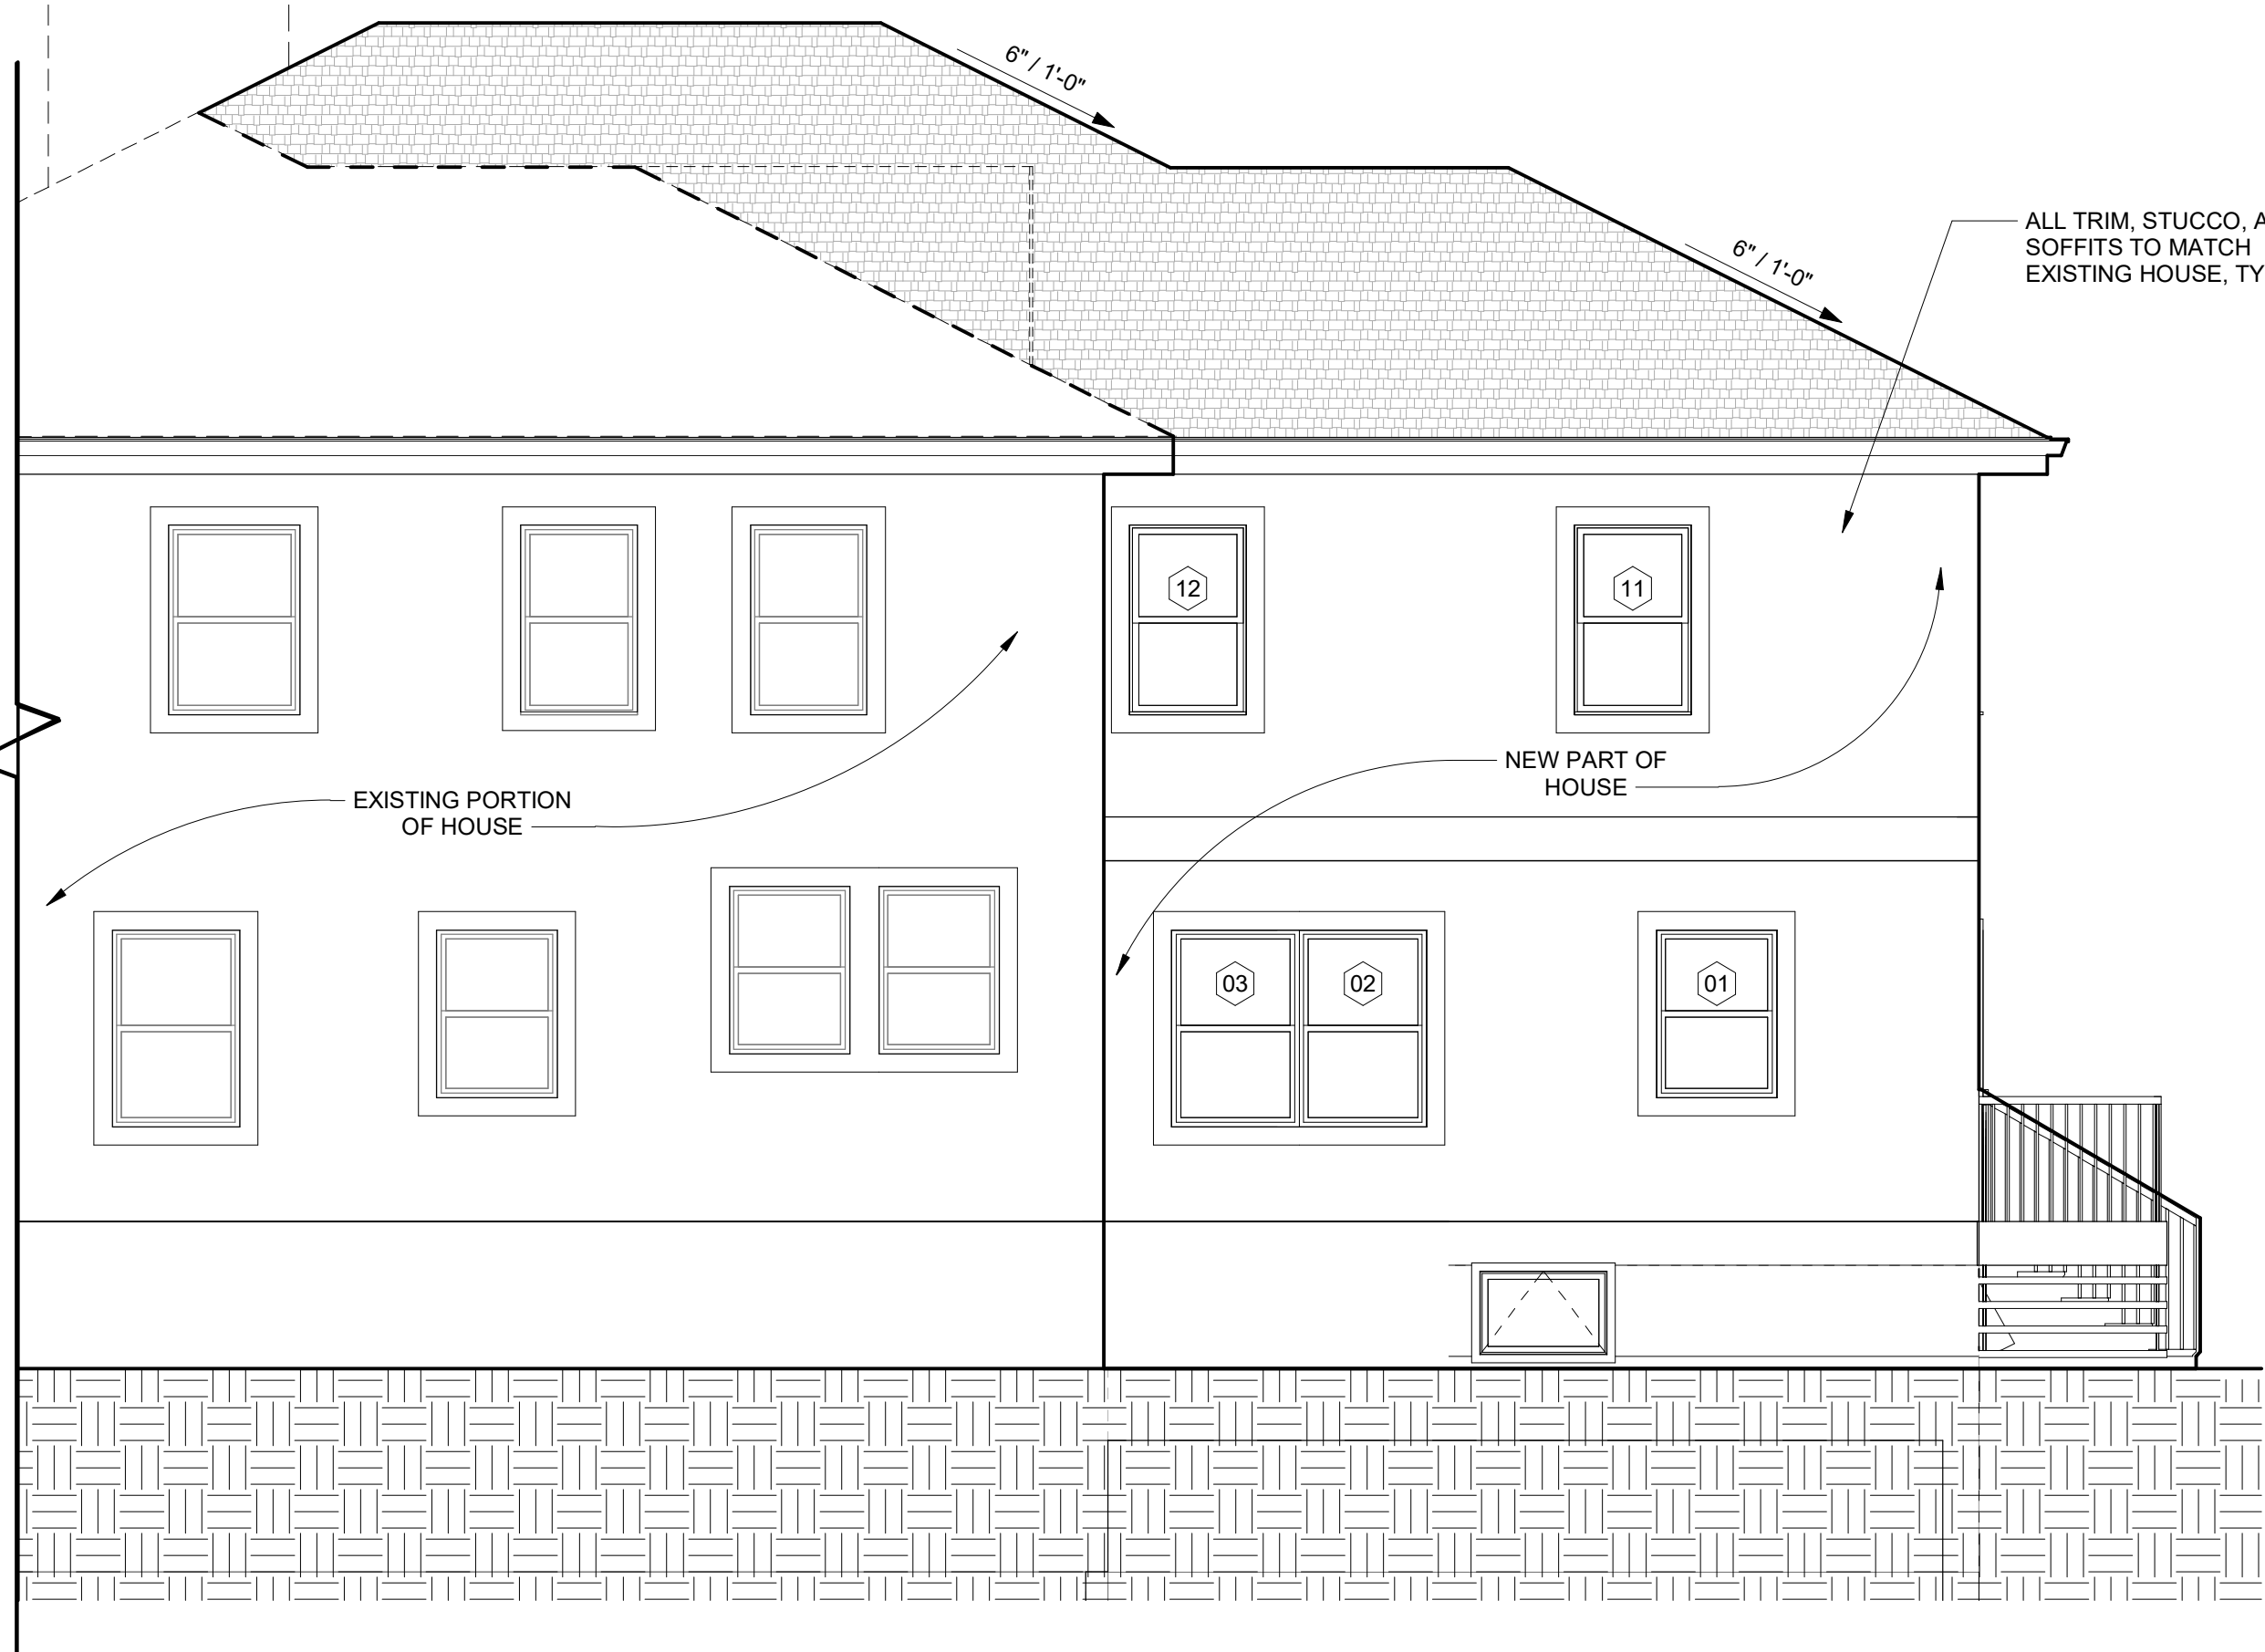

3 PROPOSED WEST (BACK) ELEVATION
1/4" = 1'-0"



NEW WINDOW/DOOR TRIM TO MATCH EXISTING WINDOW/DOOR TRIM. SEE PHOTO ABOVE





4 PROPOSED SOUTH ELEVATION
1/4" = 1'-0"



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S	Y



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SCALE	1/4" = 1'-0"
JOB	
DWG	06.28.2019
SHEET	

A-5

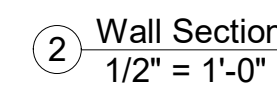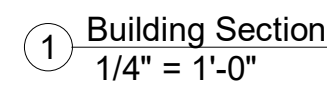

CLIMATE ZONE	FENESTRATION U-FACTOR ^a	SKYLIGHT ^a U-FACTOR	GLAZED FENESTRATION SHGC ^{a, b}	CEILING R-VALUE	WOOD FRAME WALL R-VALUE	MASS WALL R-VALUE ^c	FLOOR R-VALUE	BASEMENT ^d WALL R-VALUE	SLAB ^e R-VALUE & DEPTH	CRAWL SPACE ^f WALL R-VALUE
1	NR	0.75	0.25	30	13	3/4	13	0	0	0
2	0.40	0.65	0.25	38	13	4/6	13	0	0	0
3	0.35	0.55	0.25	38	20 or 13+5 ^b	8/13	19	5/13 ^f	0	5/13
4 except Marine	0.35	0.55	0.40	49	20 or 13+5 ^b	8/13	19	10/13	10, 2 ft	10/13
5 and Marine 4	0.32	0.55	NR	49	20 or 13+5 ^b	13/17	30 ^f	15/19	10, 2 ft	15/19
6	0.32	0.55	NR	49	20+5 or 13+10 ^b	15/20	30 ^f	15/19	10, 4 ft	15/19
7 and 8	0.32	0.55	NR	49	20+5 or 13+10 ^b	19/21	38 ^f	15/19	10, 4 ft	15/19


E-1

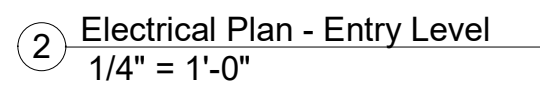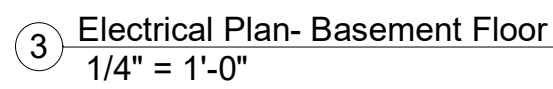


(●) - LED HIGH HAT LIGHT
 (⦿) - DIRECTED HIGH HAT LIGHT
 (○) - PENDANT
 (○) - SURFACE MOUNT FIXTURE
 (○) - WALL SCONCE
 (○) - SURFACE MOUNT FIXTURE
 [F] - EXHAUST FAN
 - - - - - UNDER CABINET LIGHTING
 (○) - CEILING FAN w/ LIGHT
 SUBCATEGORIES FOR LIGHT FIXTURES:
 WP - WATERPROOF FIXTURE
 S - SLOPED CEILING
 M - MOTION SENSOR
 ⚡ - SWITCH
 3 - 3-WAY SWITCH
 4 - 4-WAY SWITCH
 ○ - OUTLET
 GFI - GFI OUTLET
 ○ - QUAD OUTLET
 ○ - FLUSH FLOOR DUPLEX RECEPTACLE
 - - - - - UNDER-CABINET PLUG STRIP
 (J) J-BOX
 (S) SMOKE DETECTOR
 (SC) SMOKE / CARBON COMBO

1. IF NOT ALREADY INSTALLED, PROVIDE SMOKE ALARMS IN THE FOLLOWING LOCATIONS: ON EACH LEVEL OF THE STRUCTURE AND OUTSIDE EACH SEPARATE SLEEPING AREA IN THE IMMEDIATE VICINITY OF THE BEDROOMS, AND LOCATED ON OR NEAR THE CEILING. BATTERY OPERATED UNITS ARE SHALL BE PERMITTED. (5-23-6.6(f))
2. IF NOT ALREADY INSTALLED, PROVIDE CARBON MONOXIDE ALARMS IN THE FOLLOWING LOCATIONS: OUTSIDE EACH SEPARATE SLEEPING AREA IN THE IMMEDIATE VICINITY OF THE BEDROOMS (5-23-6.6(g) & IRC R-315)

PLUMBING RISER DIAGRAM

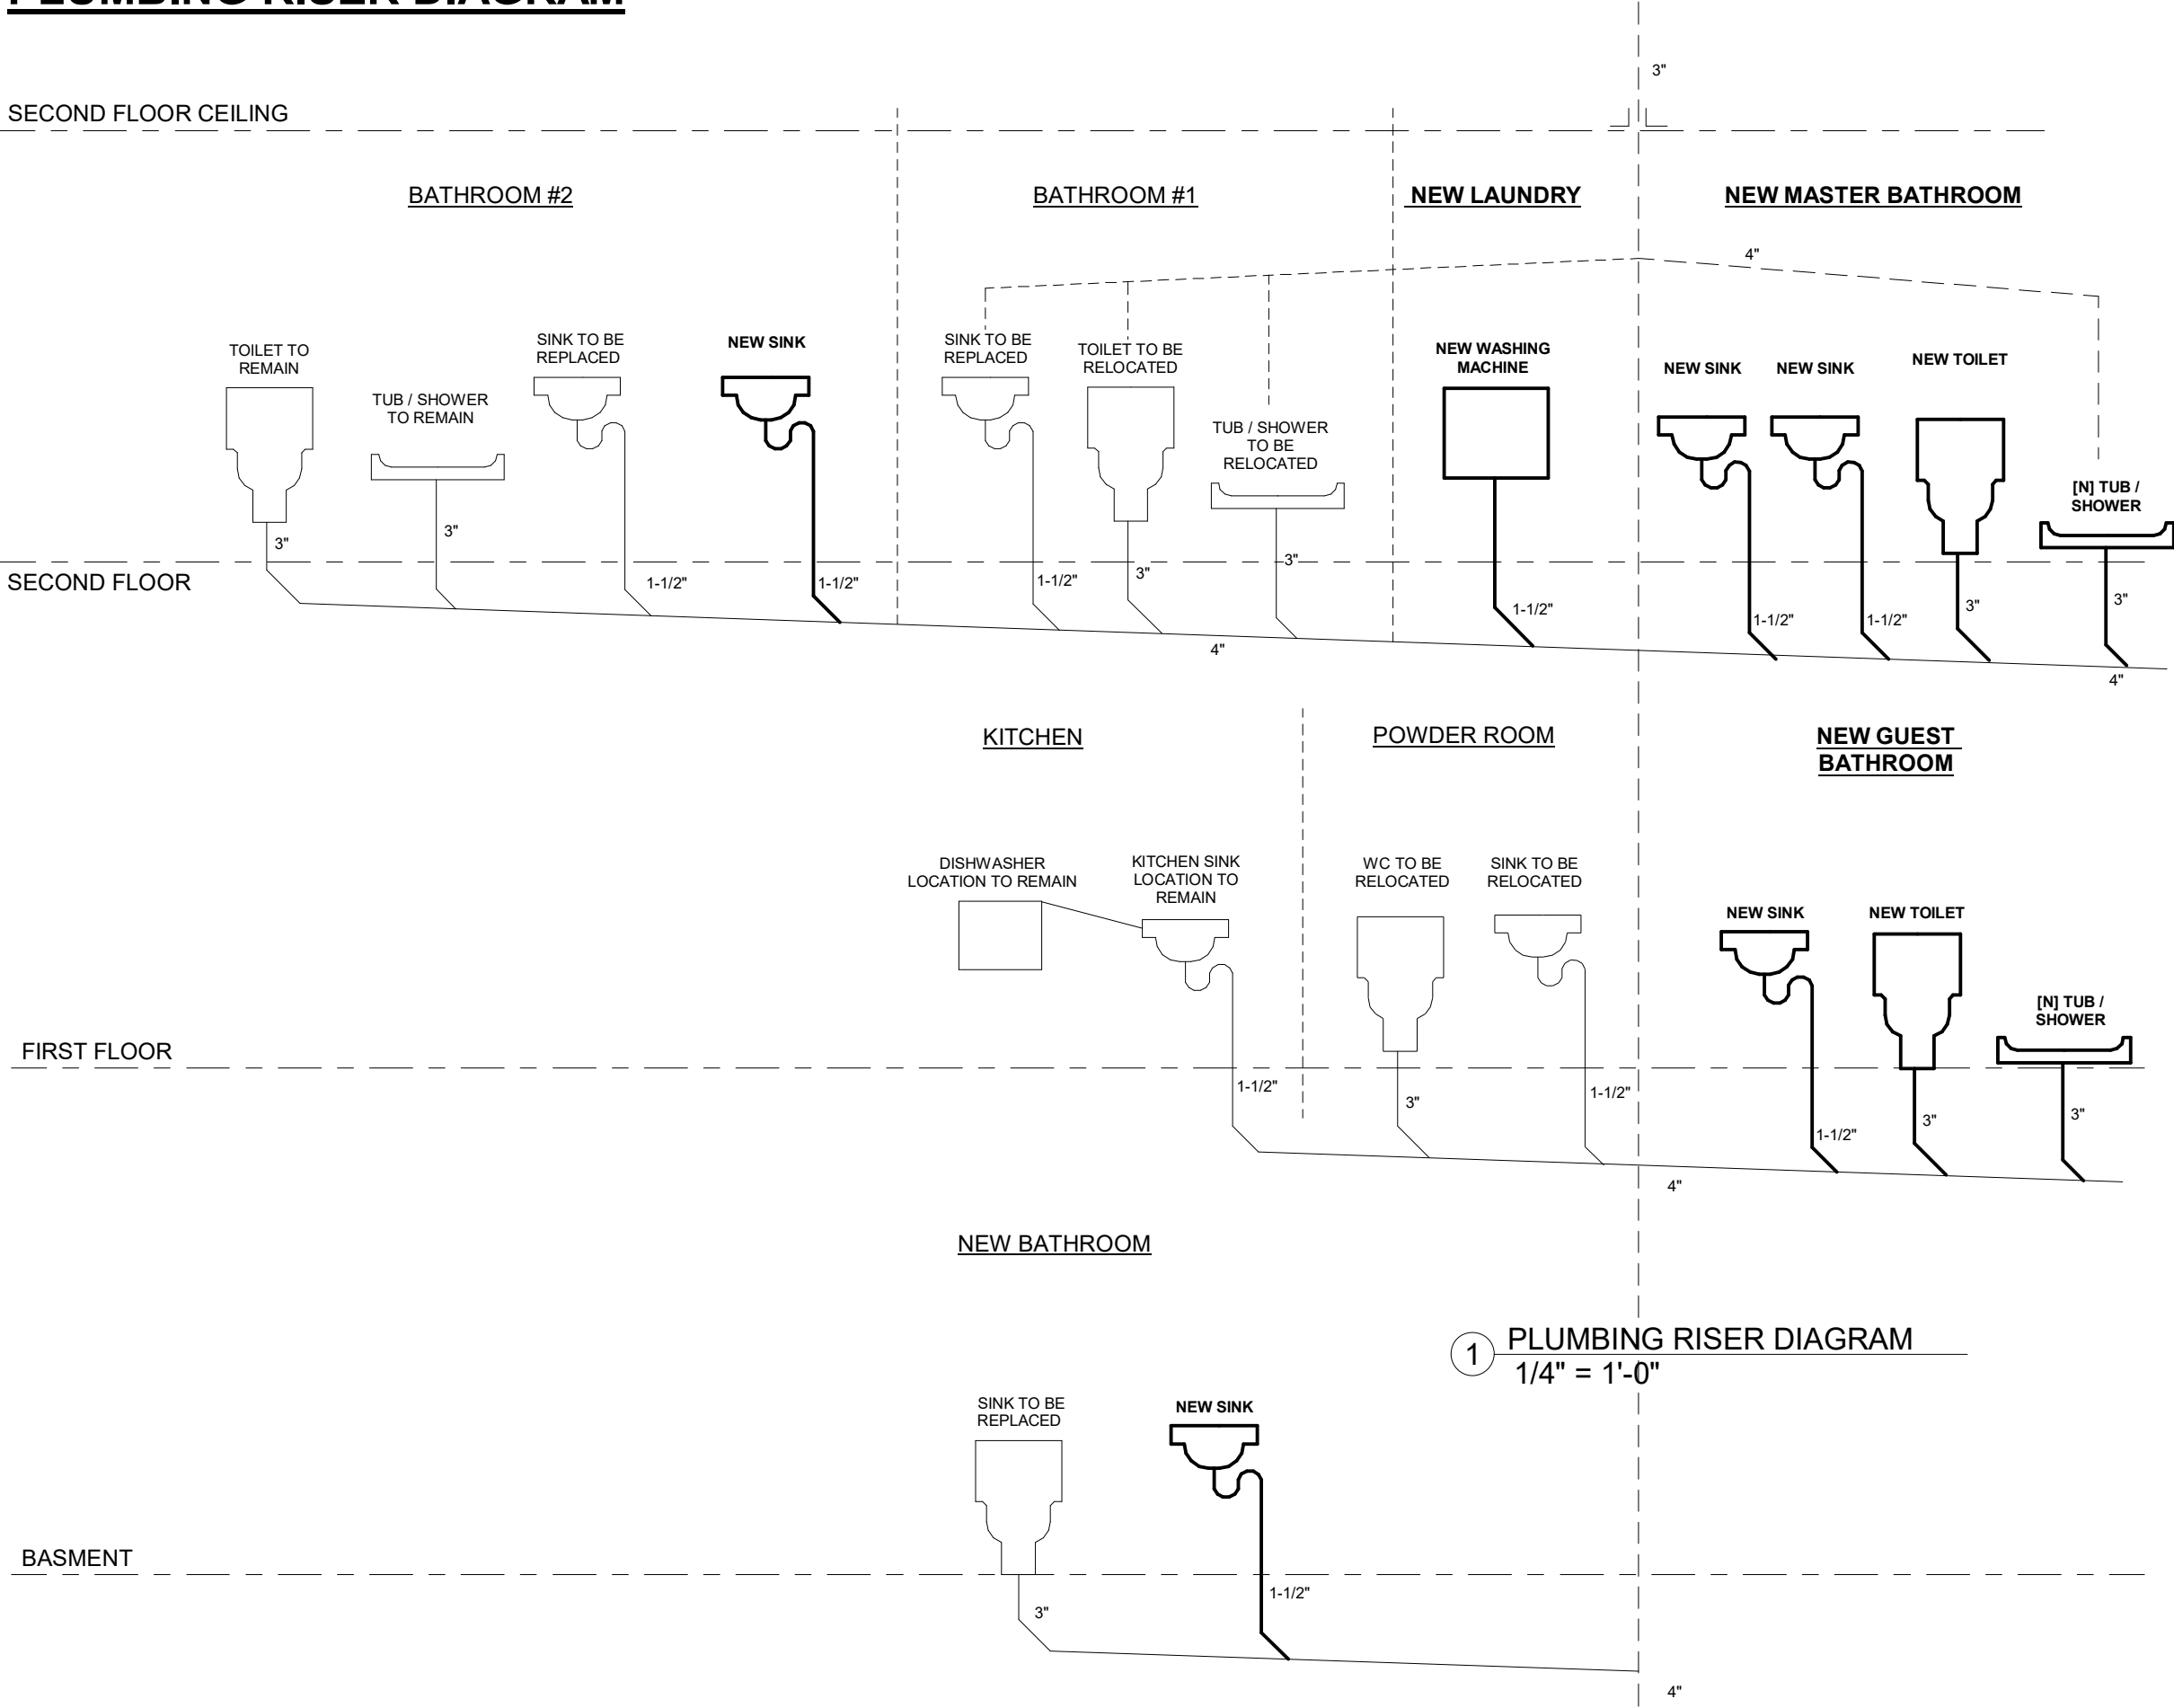

SUPPLY DIAGRAM

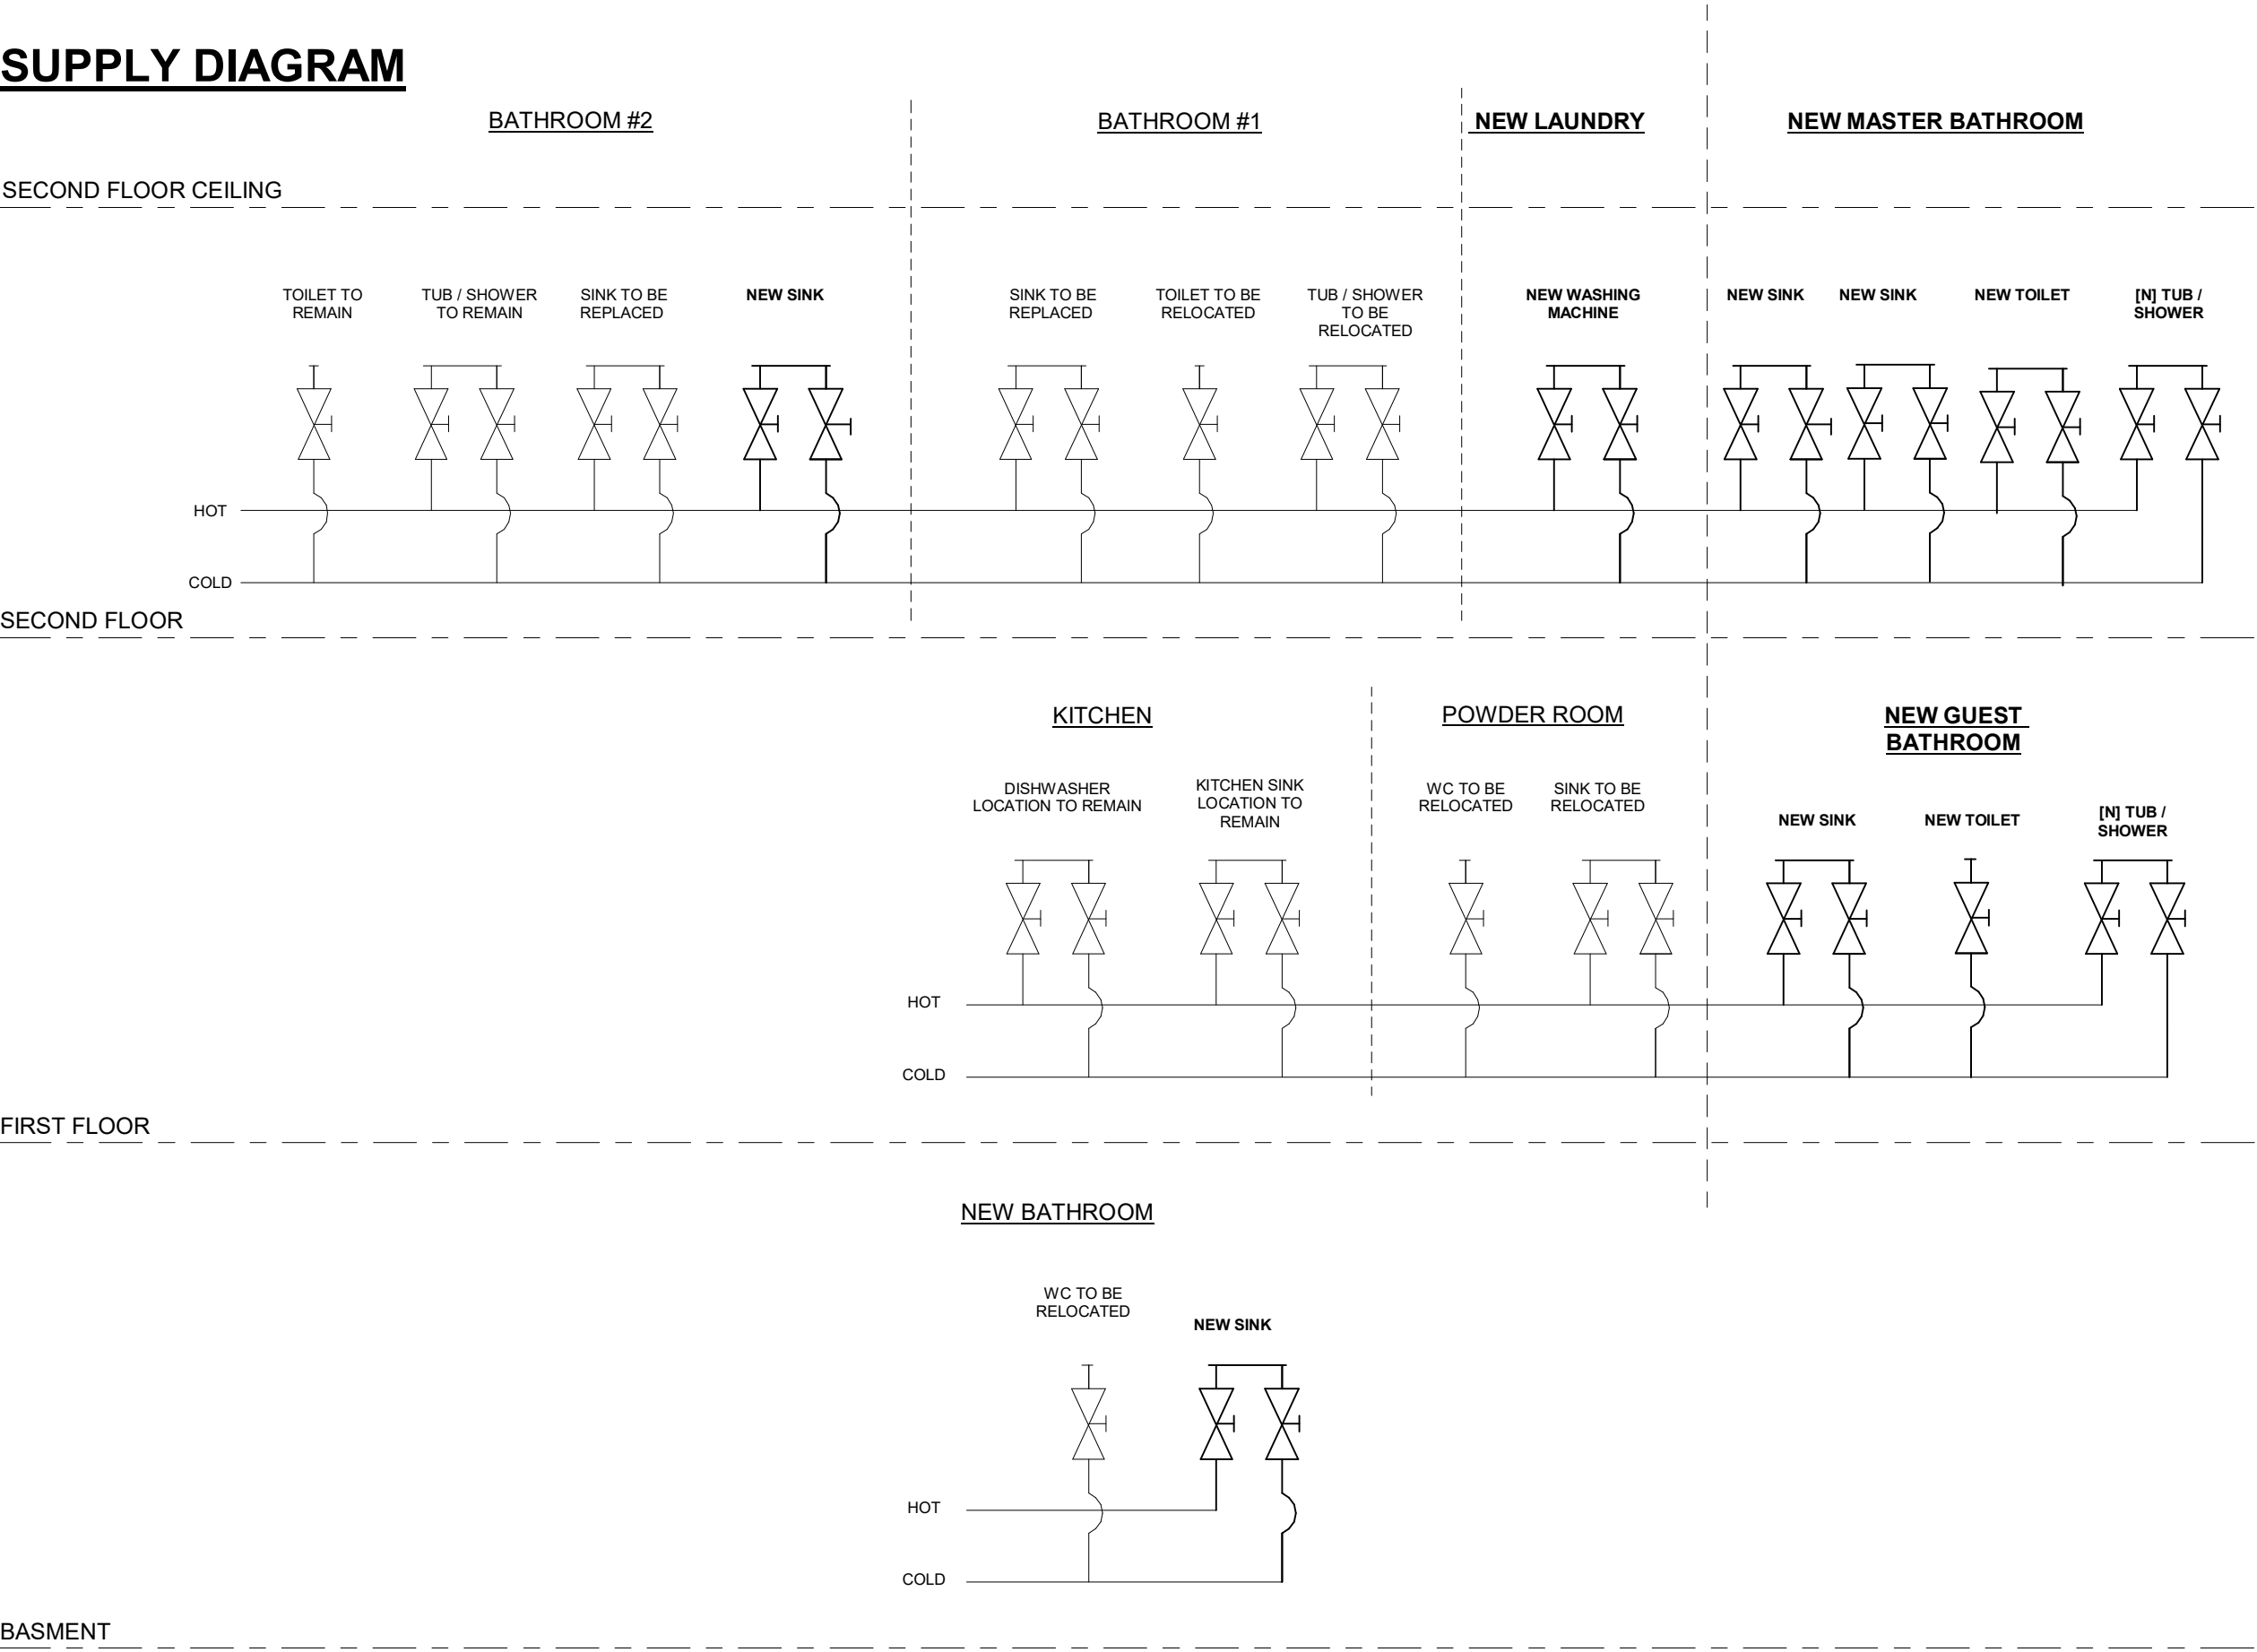

PLUMBING NOTES


1. PLUMBING INFORMATION SHOWN IS SCHEMATIC ONLY. ACTUAL INSTALLATION SHALL COMPLY WITH ALL GOVERNING CODES. ANY ADDITION INFORMATION THAT MAY BE REQUIRED BY LOCAL SUBCODE SHALL BE PROVIDED BY PLUMBING CONTRACTOR.
2. PLUMBING INFORMATION UTILIZING 2015 NATIONAL STANDARD PLUMBING CODE TABLE B.5.2.
3. EXTEND HOT AND COLD WATERLINES FROM THE EXISTING SERVICE TO THE NEW FIXTURES SHOWN ON DRAWINGS
4. SUPPLY LINES SHALL BE 1/2" DIAMETER COPPER WITH SWEAT-SOLDERED JOINTS OR 1/2" DIAMETER PEX PIPING.
5. SANITY WASTE LINE FROM THE NEW FIXTURES SHALL CONNECT INTO THE EXISTING WASTE WATER DISPOSAL SYSTEM. WASTE LINE MAY BE COPPER OR PLASTIC. PROVIDE CLEANOUTS IN CHANGES OF THE DIRECTION OF THE FLOW.
6. PROVIDE WATER SUPPLY AND DRAINAGE FITTINGS FOR ALL FIXTURES ARE SELECTED BY THE OWNER.

REVISION	B
S	Y


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DATE	
SCALE	1/4" = 1'-0"
JOB	
DWG	06.28.2019
SHEET	

Journal Pre-proof


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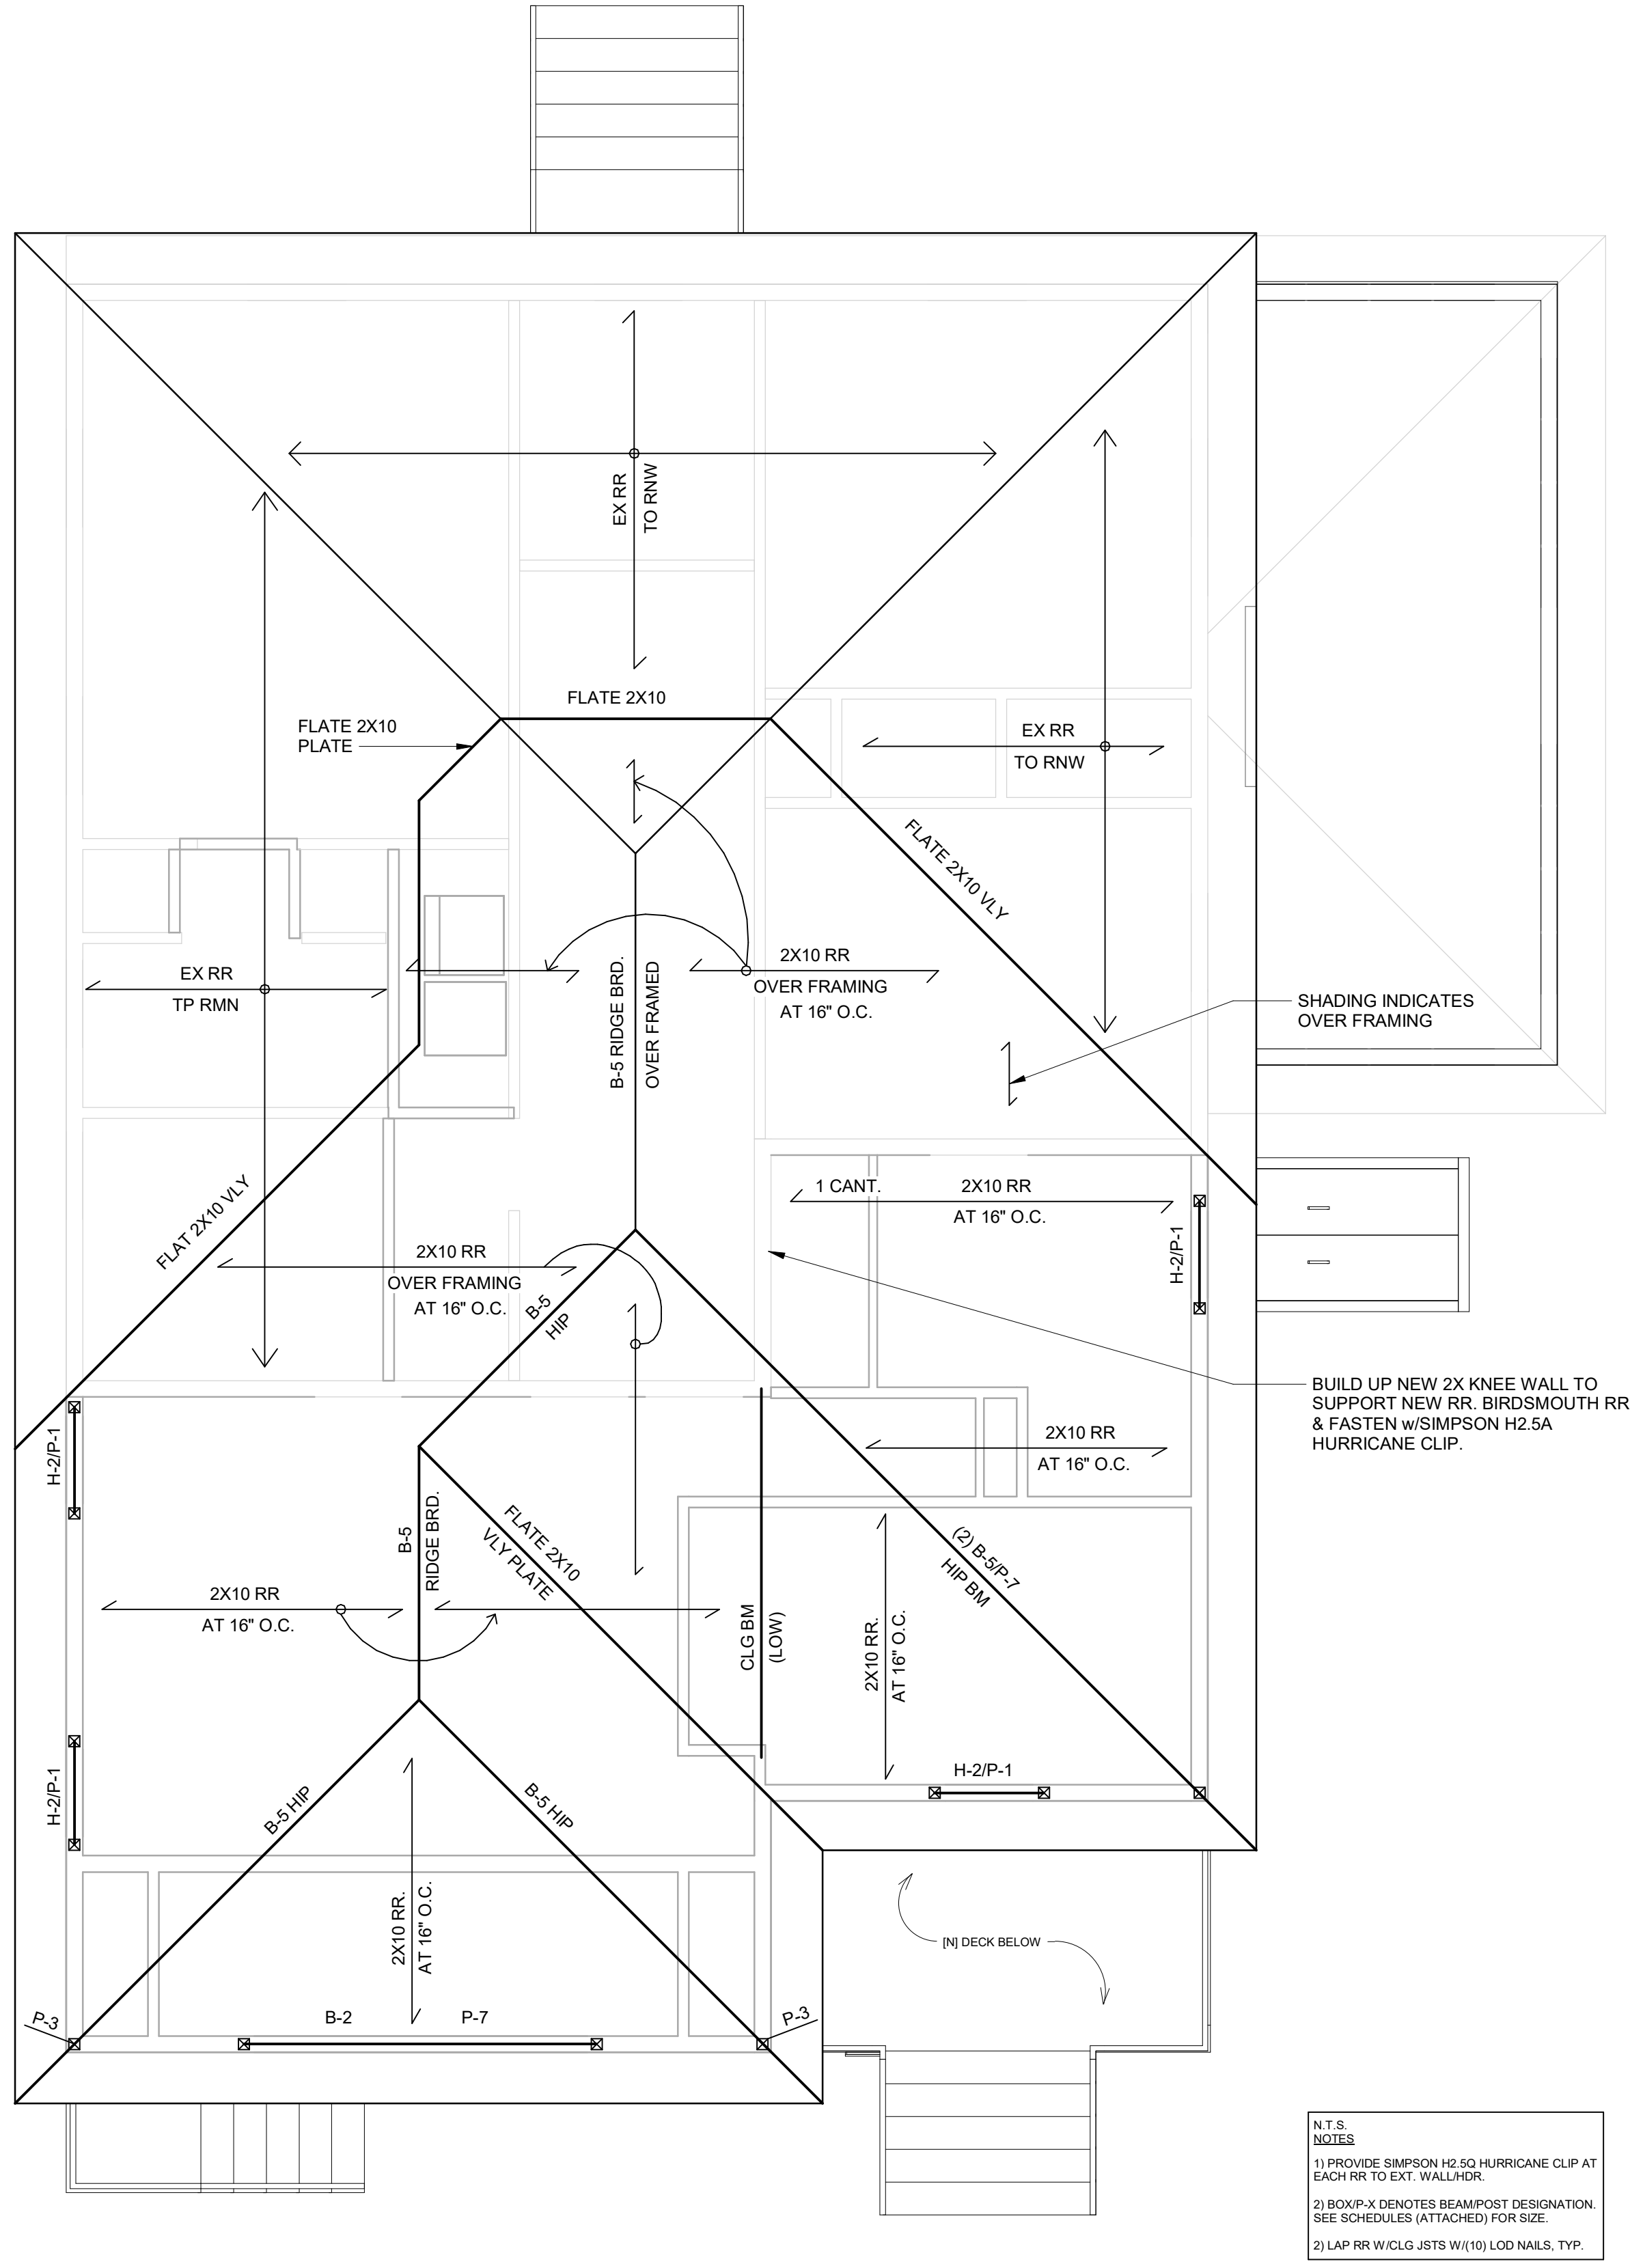
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2 Structural - Second Floor Framing Plan
(First Floor Ceiling)
1/4" = 1'-0"

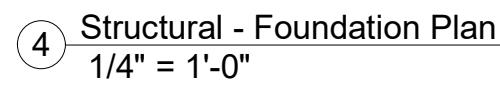

1 Structural- Second Ceiling Framing Plan
1/4" = 1'-0"

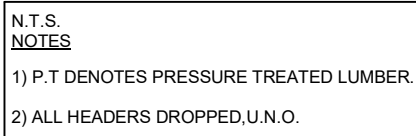

2 Structural - Roof Framing Plans
1/4" = 1'-0"

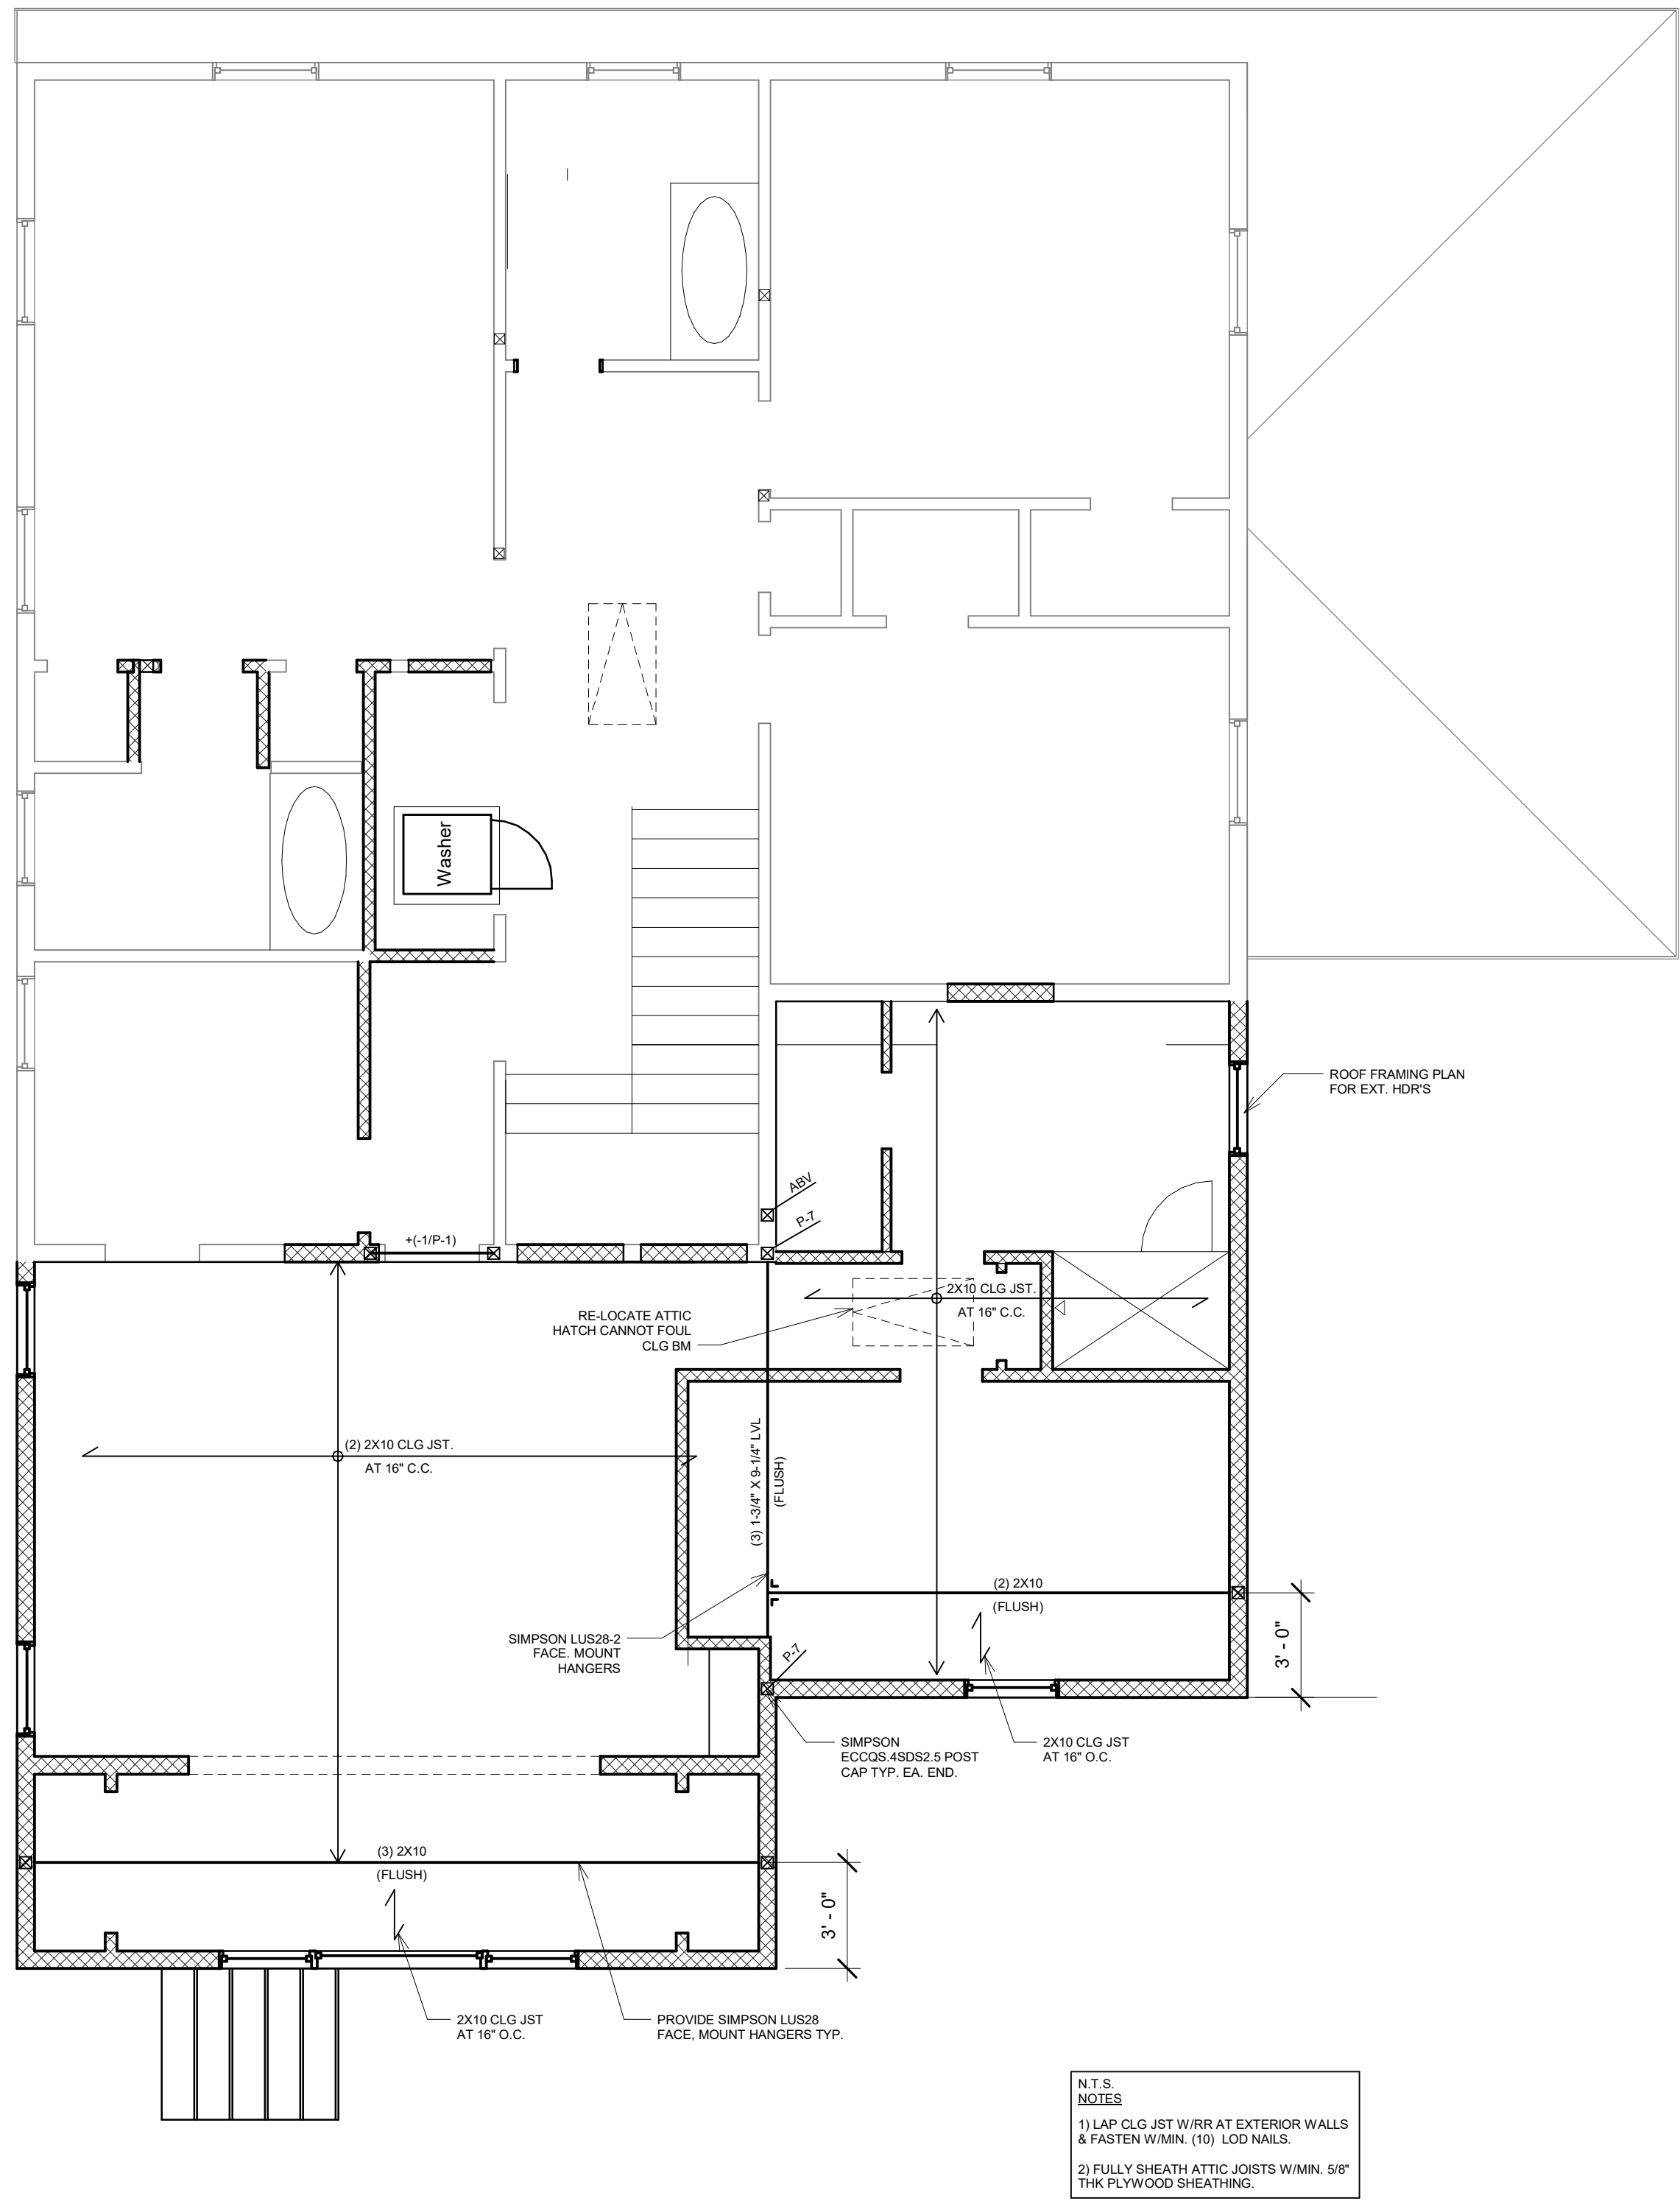REVISION	B
S	Y

DRAWN	CHECKED
DATE	
SCALE	1/4" = 1'-0"
JOB	
DWG	06.28.2019
SHEET	



HANGER SCHEDULE	
PRE-ENGINEERED BEAMS	
1-3/4x4-1/2 LVL	MT15
3-1/2x2-1/2 PSL	GLTV354
5-1/4x4-1/2 PSL	GLTV554
1-3/4x4-7/8 LVL	MT186
3-1/2x1-7/8 PSL	GLTV358
5-1/4x1-7/8 PSL	HSLTV531
7x11-7/8 LVL	HSLTV418-2
1-3/4x4 LVL	MT204
3-1/2x4 PSL	GLTV354
5-1/4x4 PSL	HSLTV534
7x4 PSL	HSLTV44-2
1-3/4x4 LVL	MT206
3-1/2x6 PSL	GLTV356
5-1/4x6 PSL	HSLTV536
7x6 PSL	HSLTV46-2

NOTES:

1. SEE STRUCTURAL NOTES FOR REQUIRED MOOD SPECIES AND GRADE.
2. PROVIDE 1/2" PLYWOOD SHIM BETWEEN EACH PLY. MATCH DEPTH OF HEADER FOR 2x6 MULTIPLE MEMBERS GLE AND NAIL EACH PLY W (3) ROWS OF 16d NAILS @ 8" O.C.
3. FOR 2x10 AND 2x12 MULTIPLE MEMBERS GLE AND NAIL EACH PLY W (4) ROWS OF 16d NAILS AT 8" O.C.
4. NAIL OR BOLT MULTIPLE LVL BEAMS AND HEADERS PER MANUFACTURERS REQUIREMENTS.
5. FOR REQUIRED MOOD MEMBERS MAY BE SUBSTITUTED FOR THE 2x MOOD HEADERS SHOWN ON THE DRAWINGS, THE CONTRACTOR SHALL SUBMIT SHOP DRAWINGS FOR APPROVAL, PRIOR TO CONSTRUCTION.

REVISION S	B Y

DRAWN	CHECKED
DATE	
SCALE	12" = 1'-0"
JOB	
DWG	06.28.2019
SHEET	

S-2